

November 19, 2024

File: 161414396

**Attention: David Ailles**

York Developments  
303 Richmond Street #201  
London, ON, N6A 4L9

Dear David,

**Reference: Arva Development – Sanitary Servicing Brief**

This letter is written to support the future subdivision development located within the settlement boundary of Arva within the Municipality of Middlesex Centre, in providing information on the anticipated sewage flows of the development. The proposed Subdivision includes 23.516 Ha of land comprised of parcels west of Richmond Street and both north and south of Medway Road. The development is proposed to include approximately 932 residential units, as per the latest draft plan of subdivision completed by MHBC Ltd., attached. The development is comprised of a mix of low, medium and high density blocks for a total population of 1,950 as broken down below.

**Table 1 – Proposed Population**

Blocks	Residential Type	Area (ha)	No. Units	Population Density (P/unit)	Population
1, 3, 7, 16-21, 24, 25	LD	7.964	122	3	366
5, 9, 10, 12, 22, 27	MD Street Townhouses	1.594	49	2.4	118
13-15	MD Cluster Townhouses	1.893	62	2.4	149
8, 11	MD Apartments	2.314	247	2.4	593
23	HD Apartments	1.940	452	1.6	724
<b>Total</b>			<b>932</b>		<b>1,950</b>

\*Population Densities based on City of London DSRM

It is anticipated that the development will be broken down into several phases. However, for this analysis sanitary sewage flows will be calculated based on an ultimate condition with the aforementioned total population.



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**Reference: Arva Development – Sanitary Servicing Brief**

### **Existing Sanitary Infrastructure & Sewage Flows**

Currently there exists a 200mm sanitary gravity sewer along Medway Road that is capped approximately 100m west of Richmond Street. This sewer ultimately Leads to the existing Arva Pump Station along Richmond Street, approximately 400 meters south of Medway Road via a 250mm sanitary gravity sewer.

The pump station is comprised of a 3m diameter wet well equipped with two (2) submersible pumps (one standby), and a 3m square precast concrete chamber housing two (2) dry pit booster pumps (one standby). The submersible pump and dry pit booster pump operate in series to provide a firm station capacity of approximately 30 L/s at 60m TDH. The station discharges via a 150mm diameter forcemain, 1,713m along Richmond Street into a sanitary manhole located at the junction of Plane Tree Drive and Richmond Street.

Currently an agreement between the Municipality of Middlesex Centre and the City of London limits the discharge to 175 m<sup>3</sup>/day on a two-month rolling average. Based on recent data collection, the average daily flow over 2020 and 2021 is approximately 85 m<sup>3</sup>/day with one peak month averaging near 140 m<sup>3</sup>/day. An estimated annual average flow of 92.5 m<sup>3</sup>/day is used as further calculated in this brief. These flows are assumed to be contributed by a theoretical population of 600 as per the current build out. This results in an approximate average sewage flow of 154.2 L/cap/day.

### **Proposed Sanitary Flows**

As mentioned in table 1, the proposed development is anticipated to introduce an additional population of 1,950 people in the community of Arva. The proposed peak sanitary flows based on the City of London standards (230 L/cap/day and 0.1 L/s/ha for infiltration) are broken down in the below table.

**Table 2 – Proposed Peak Sanitary flow**

Area (ha)	Population	Peaking Factor	Q <sub>people</sub> (L/s)	Q <sub>infiltration</sub> (L/s)	Q <sub>total</sub> (L/s)	Q <sub>total</sub> (m <sup>3</sup> /day)
23.516	1,950	3.59	20.52	2.35	22.88	1,977

Therefore, the ultimate buildout of the development is anticipated to contribute a maximum sanitary peak flow including inflow and infiltration of 22.88 L/s (1,977 m<sup>3</sup>/day). These flows will require to be conveyed to the City of London via a sanitary pump station, sanitary forcemain or gravity sewer. The average sanitary flow for the development can be calculated by removing the peaking factor, as a result the average sanitary flow is 8.06 L/s as broken down in the below table.



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**Reference:** Arva Development – Sanitary Servicing Brief

**Table 3 – Proposed Average Sanitary Flows**

Area (ha)	Population	Q <sub>people</sub> (L/s)	Q <sub>infiltration</sub> (L/s)	Q <sub>total</sub> (L/s)	Q <sub>total</sub> (m <sup>3</sup> /day)
23.516	1,950	5.71	2.35	8.06	697

### Arva Pump Station

Based on the previously mentioned discharge rate to the City of London, the existing Arva pump station is expected to be able to take on an additional 82.5 m<sup>3</sup>/day (82,500 L/day) on average, as broken down below:

$$\text{Annual Average Flow} = \frac{(85 \times 10 \text{months}) + (140 \times 1 \text{month}) + (120 \times 1 \text{month})}{12 \text{ months}} = 92.5 \text{ m}^3/\text{day}$$

$$\text{City of London Discharge Agreement} = 175 \text{ m}^3/\text{day}$$

$$\text{Available Sanitary Discharge} = 175 \frac{\text{m}^3}{\text{day}} - 92.5 \frac{\text{m}^3}{\text{day}} = 82.5 \text{ m}^3/\text{day}$$

The above calculated flows are based on existing and anticipated average flows and not peak flows. Peak flows shall be used when designing the sanitary sewer collection system. Moreover, inflow and infiltration shall also be taken into consideration and will be dependent on the developable area. Therefore, using the city of London average sanitary flow of 230 L/capita/day the Arva pump station is anticipated to be capable of taking on an additional 359 people or 120 low-density residential units, as broken down below:

**Table 3 – Arva Pump Station Available Capacity**

	Total Available Flow (L/day)	Corresponding Population (230 L/cap/day)	Corresponding Low-density Units (3p/unit)
Average	82,500	359	120

Thus, contribution from the proposed development (697 m<sup>3</sup>/day) will require an increase in the agreed upon sanitary discharge rate to the City of London (175 m<sup>3</sup>/day of which 82.5 m<sup>3</sup>/day is available) as well as an expansion of the Arva pump station. The proposed development will require an additional sanitary discharge rate of 614.5 m<sup>3</sup>/day. Alternatively, a new pump station may be introduced with adequate capacity to take on the proposed sanitary flows of the



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**Reference: Arva Development – Sanitary Servicing Brief**

development with corresponding sanitary forcemain which outlets to the existing downstream sanitary infrastructure in the City of London.

**Village Walk Boulevard Sanitary Sewer**

The existing sanitary gravity sewer at the intersection of Village Walk Boulevard and Richmond Street within the City of London has available capacity of 29.6 L/s (peak flow) allocated to Arva. With this capacity allocated to Arva, there is enough to accommodate the proposed development with its estimated sanitary peak flow contribution of 22.88 L/s. The proposed subdivision would not be able to be conveyed to this sewer by gravity and would require a pumping station and forcemain.

**Conclusion**

We trust this meets your requirements for confirmation on the proposed development's sanitary peak flows in compliance with City of London Standards. Should you have any questions or require anything further, please do not hesitate to contact the undersigned.

Sincerely,

**STANTEC CONSULTING LTD.**

A handwritten signature in black ink, appearing to read "Abdalla Shaat".

Abdalla Shaat, EIT  
Civil Engineering Designer, Project Coordinator  
Community Development  
Phone: 519-670-7137  
Abdalla.Shaat@stantec.com

A handwritten signature in black ink, appearing to read "Darryl Hern".

Darryl Hern, P.Eng.  
Project Manager  
Community Development  
Phone: 519-675-6622  
Darryl.Hern@stantec.com

Attachment: - Preliminary Draft Plan of Subdivision MHBC, November 2024  
- Arva Sanitary Sewage System as-builts




PART OF LOT 17,  
CONCESSION 6 & 7  
MUNICIPALITY OF MIDDLESEX CENTRE  
COUNTY OF MIDDLESEX

I HEREBY AUTHORIZE MACNAUGHTON HERMSEN BRITTON CLARKSON PLANNING LIMITED TO  
SUBMIT THIS PLAN FOR APPROVAL.

## **Surveyor's Certificate**

HEREBY AUTHORIZE CERTIFY THAT THE BOUNDARIES OF THE LAND TO BE SUBDIVIDED ON THIS PLAN AND THEIR RELATIONSHIP TO THE ADJACENT LANDS ARE ACCURATELY AND CORRECTLY SHOWN.

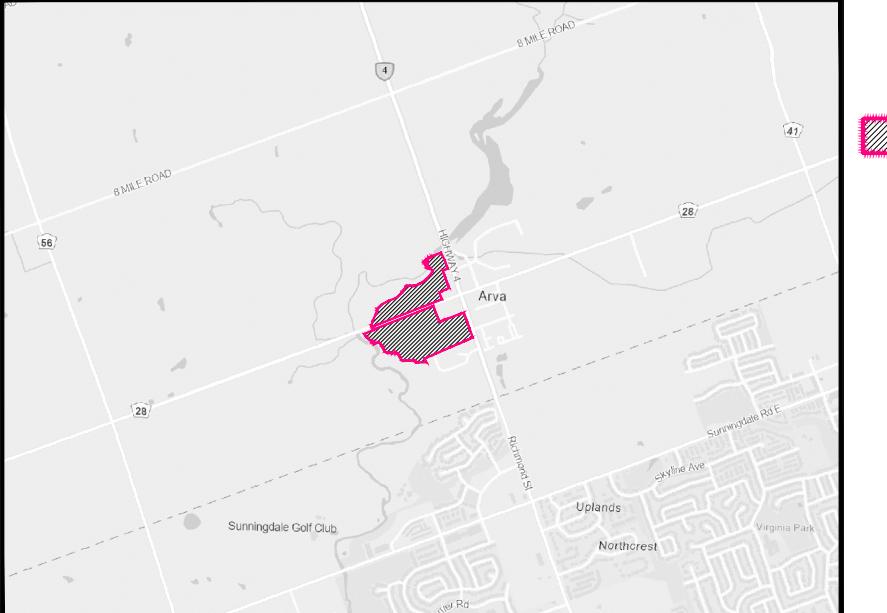

## Subject Lands

**SCALE**

SUBJECT TO THE CONDITIONS, IF ANY, SET FORTH IN OUR LETTER DATED \_\_\_\_\_, 2020  
THIS DRAFT PLAN IS APPROVED UNDER SECTION 51 OF THE PLANNING ACT  
\_\_\_\_\_       DAY OF \_\_\_\_\_, 2020

4	November 15, 2024	Request from Client	PL
3	October 18, 2024	Request from Client	PL
2	October 1, 2024	Revised Apartment blocks, SWM	PL
	July 26, 2024	Issued	CCF

**Additional Information Required Under Section 51(17) of the Planning Act R.S.O. 1990, c.P.13 as Amended**

A. As Shown	B. As Shown	C. As Shown
D. Residential	E. As Shown	F. As Shown
G. As Shown	H. Municipal Water Supply Available	I. Silt Loam
J. As Shown	J. All Services As Required	L. As Shown

Description	Lots/Blocks	Units	Area (ha)
Low Density Residential	1, 3, 7, 16 - 21, 24, 25	122	8.031
Medium Density Residential (Street Townhouses)	5, 9, 10, 12, 22, 27	49	1.594
Medium Density Residential (Cluster Townhouses)	13 - 15	62	1.893
Medium Density Residential (Apartments)	8, 11, 23	699	4.216
Park	35		0.603
Walkway	31, 43		0.082
Maintenance Setback	4, 6		0.584
Storm Water Management	30, 37		1.275
Pump Station	36		0.160
Open Space	2, 29		0.753
0.3m Reserves	40, 41		0.009
Road Widening	32, 33		0.457
Roads			3.860




# PLANNING URBAN DESIGN & LANDSCAPE ARCHITECTURE


DEVELOPMENTS 540 BINGEMANS CENTRE DRIVE, SUITE 200, KITCHENER, ON, N2B 3X9 | P: 519 576 3650 | WWW.MHBCPLAN.COM

# PRELIMINARY DRAFT PLAN OF SUBDIVISION

Plan Scale 1:2000

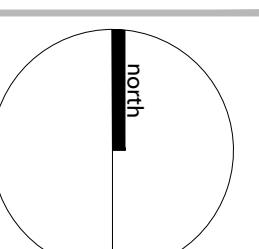

# ARVA SANITARY SEWAGE SYSTEM

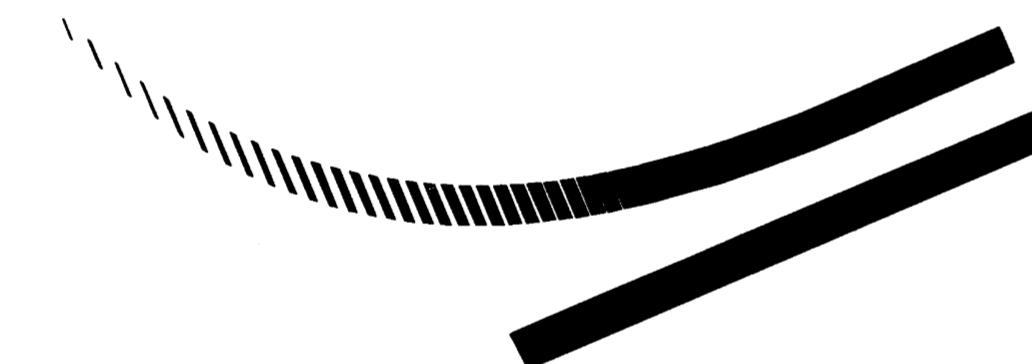


**DILLON**  
CONSULTING




TOWNSHIP  
OF  
MIDDLESEX  
CENTRE

## LIST OF DRAWINGS


1. GENERAL ARRANGEMENT OF SERVICES, SANITARY DRAINAGE PLAN AND DESIGN CHART
2. MEDWAY ROAD (MIDDLESEX COUNTY ROAD 28) – FROM 153m WEST OF RICHMOND ST TO 45m WEST OF ELGIN ST
3. MEDWAY ROAD (MIDDLESEX COUNTY ROAD 28) – FROM 45m WEST OF ARVA ST TO 320m EAST OF ARVA ST
4. RICHMOND ST (KING'S HIGHWAY No. 4) – FROM 78m NORTH OF ELGIN ST TO 151m SOUTH OF MEDWAY RD
5. RICHMOND ST (KING'S HIGHWAY No. 4) – FROM 145m NORTH OF ST. JOHN'S DRIVE  
TO 125m SOUTH OF CROYDON DRIVE
6. WELDON AVENUE – FROM RICHMOND ST TO ARVA ST
7. ST. JOHN'S DRIVE – FROM RICHMOND ST TO ARVA ST
8. ARVA STREET – FROM MEDWAY RD TO ST. JOHN'S DRIVE
9. ELGIN STREET – FROM RICHMOND ST TO MEDWAY RD
10. CROYDON DRIVE – FROM 435m WEST OF RICHMOND ST TO 120m WEST OF RICHMOND ST
11. CROYDON DRIVE – FROM 120m WEST OF RICHMOND ST TO RICHMOND ST  
CROYDON PLACE
12. MURPHY/VEEL PRIVATE LANE – FROM 70m NORTH OF MEDWAY ROAD TO MEDWAY ROAD, BLOCK 'D' FROM  
CROYDON DRIVE TO RICHMOND STREET
13. FORCEMAIN – FROM PUMPING STATION TO 660m NORTH OF SUNNINGDALE ROAD
14. FORCEMAIN – FROM 660m NORTH OF SUNNINGDALE ROAD TO 300m NORTH OF SUNNINGDALE ROAD
15. FORCEMAIN – FROM 300m NORTH OF SUNNINGDALE ROAD TO SUNNINGDALE ROAD
16. FORCEMAIN – FROM SUNNINGDALE ROAD TO 300m NORTH OF PLANE TREE DRIVE
17. FORCEMAIN – FROM 300m NORTH OF PLANE TREE DRIVE TO PLANE TREE DRIVE
18. PUMPING STATION – SITE LAYOUT & GENERAL ARRANGEMENT
19. PUMPING STATION – PLANS AND SECTIONS
20. WELDON / CARTER EASEMENT – FROM 168m NORTH OF MEDWAY RD TO MEDWAY RD
21. ELGIN STREET – SANITARY PRESSURE SEWER
22. MISCELLANEOUS DETAILS ONE – FORCEMAIN
23. MISCELLANEOUS DETAILS TWO – FORCEMAIN
24. MISCELLANEOUS DETAILS THREE – COLLECTION SYSTEM
25. MISCELLANEOUS DETAILS FOUR – COLLECTION SYSTEM

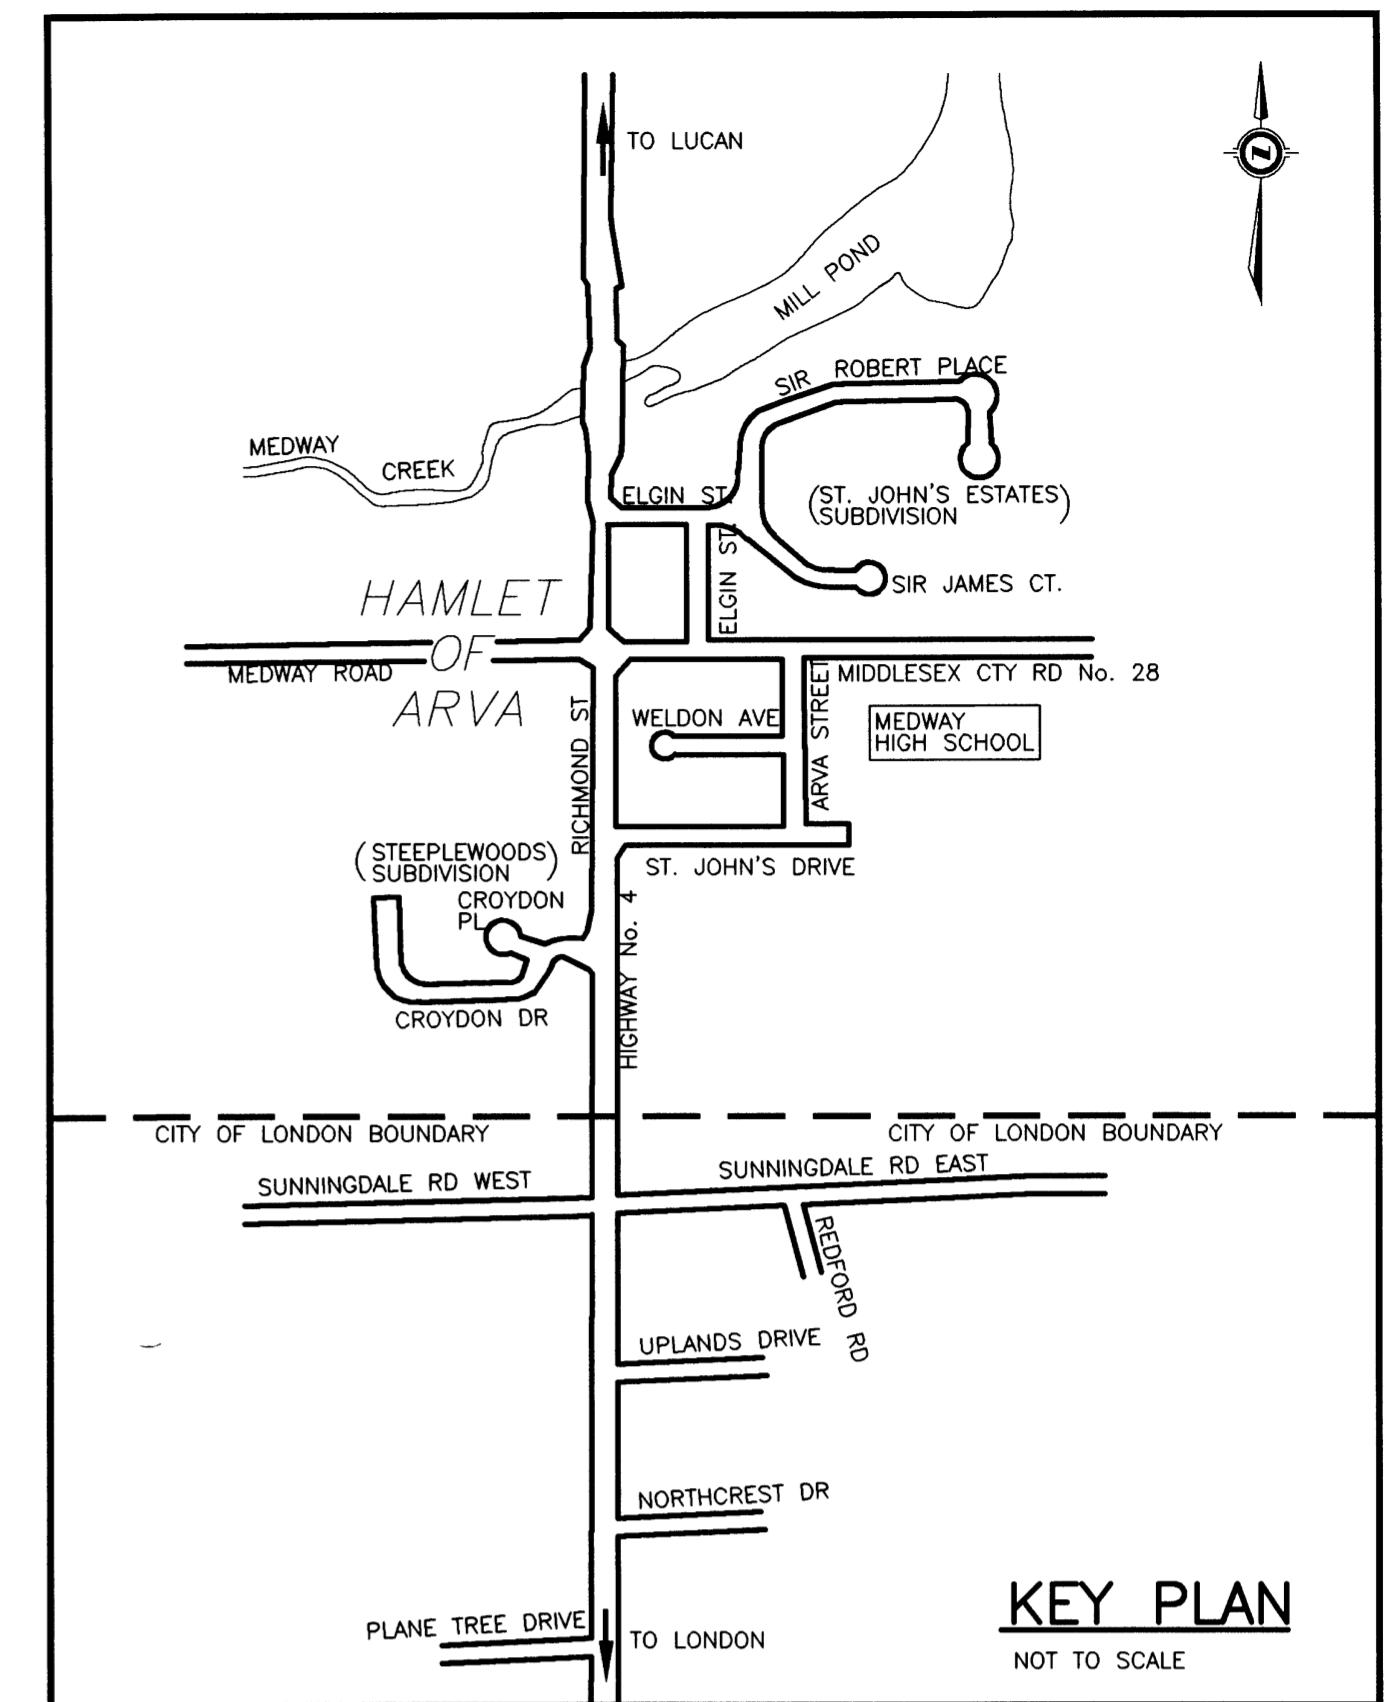

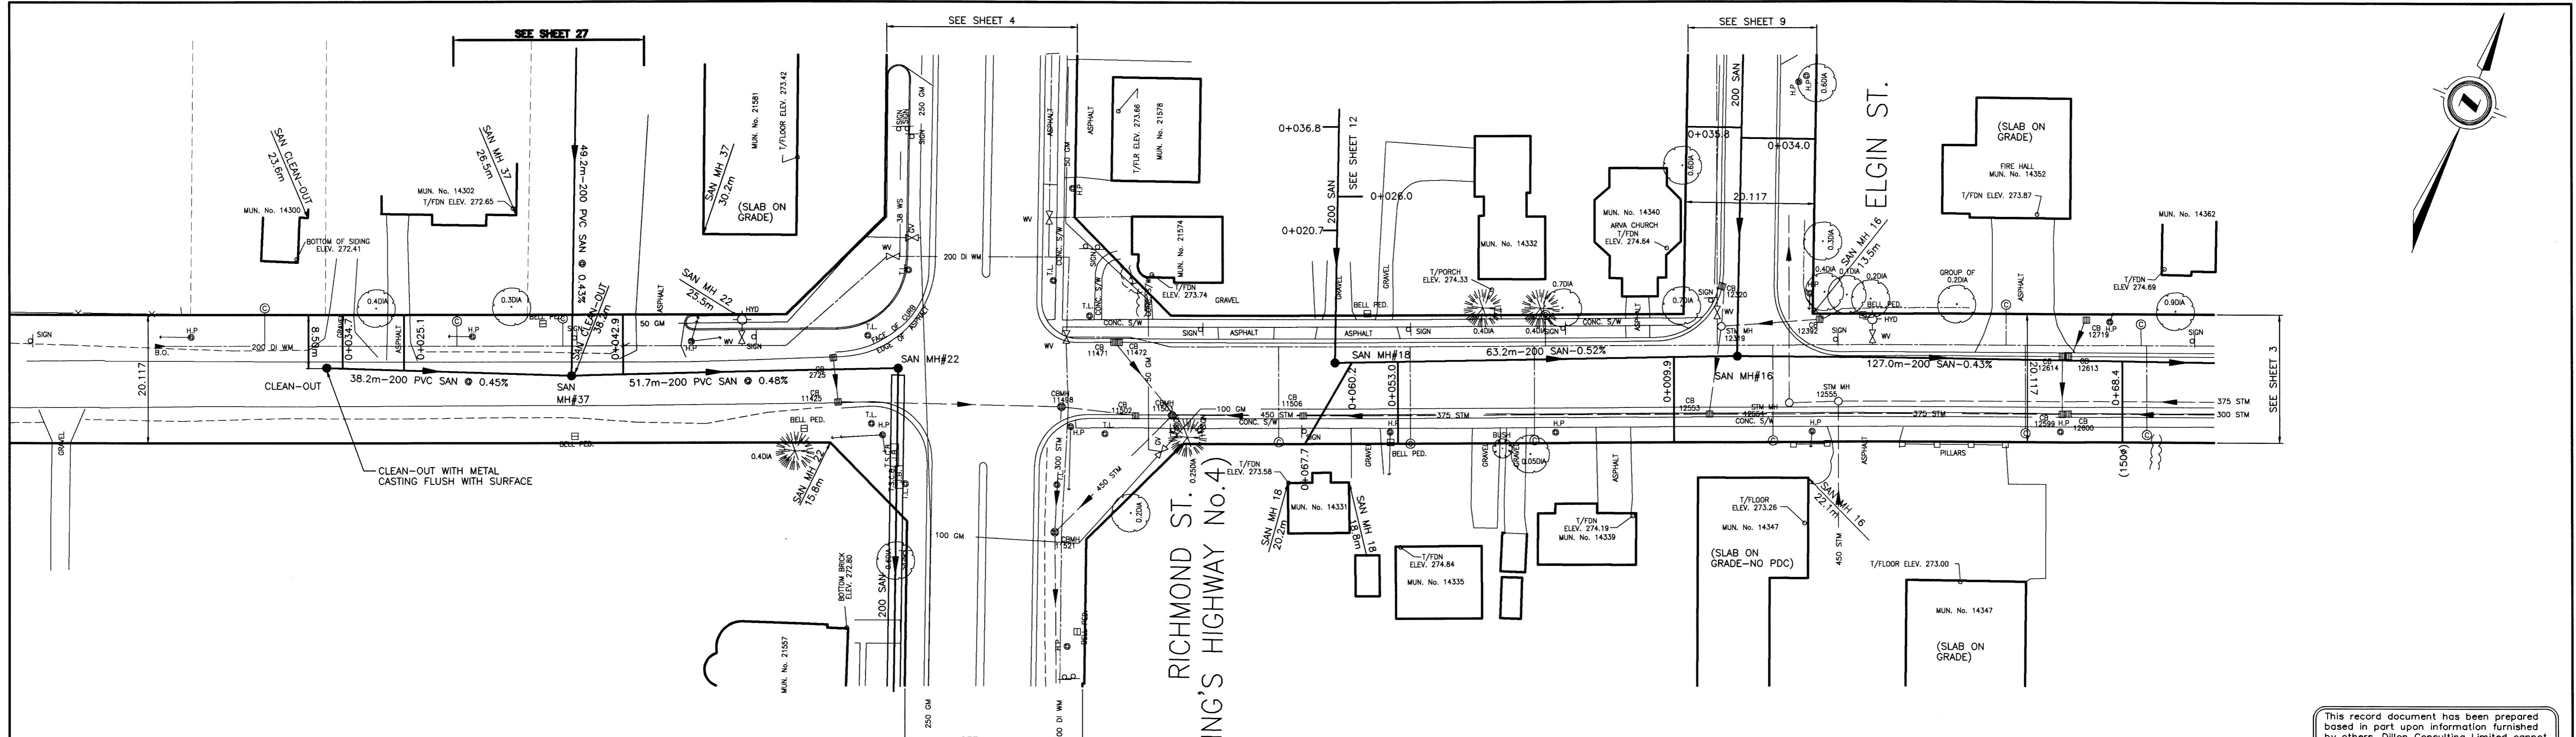



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### MEDWAY ROAD - (MIDDLESEX COUNTY ROAD NO. 28)

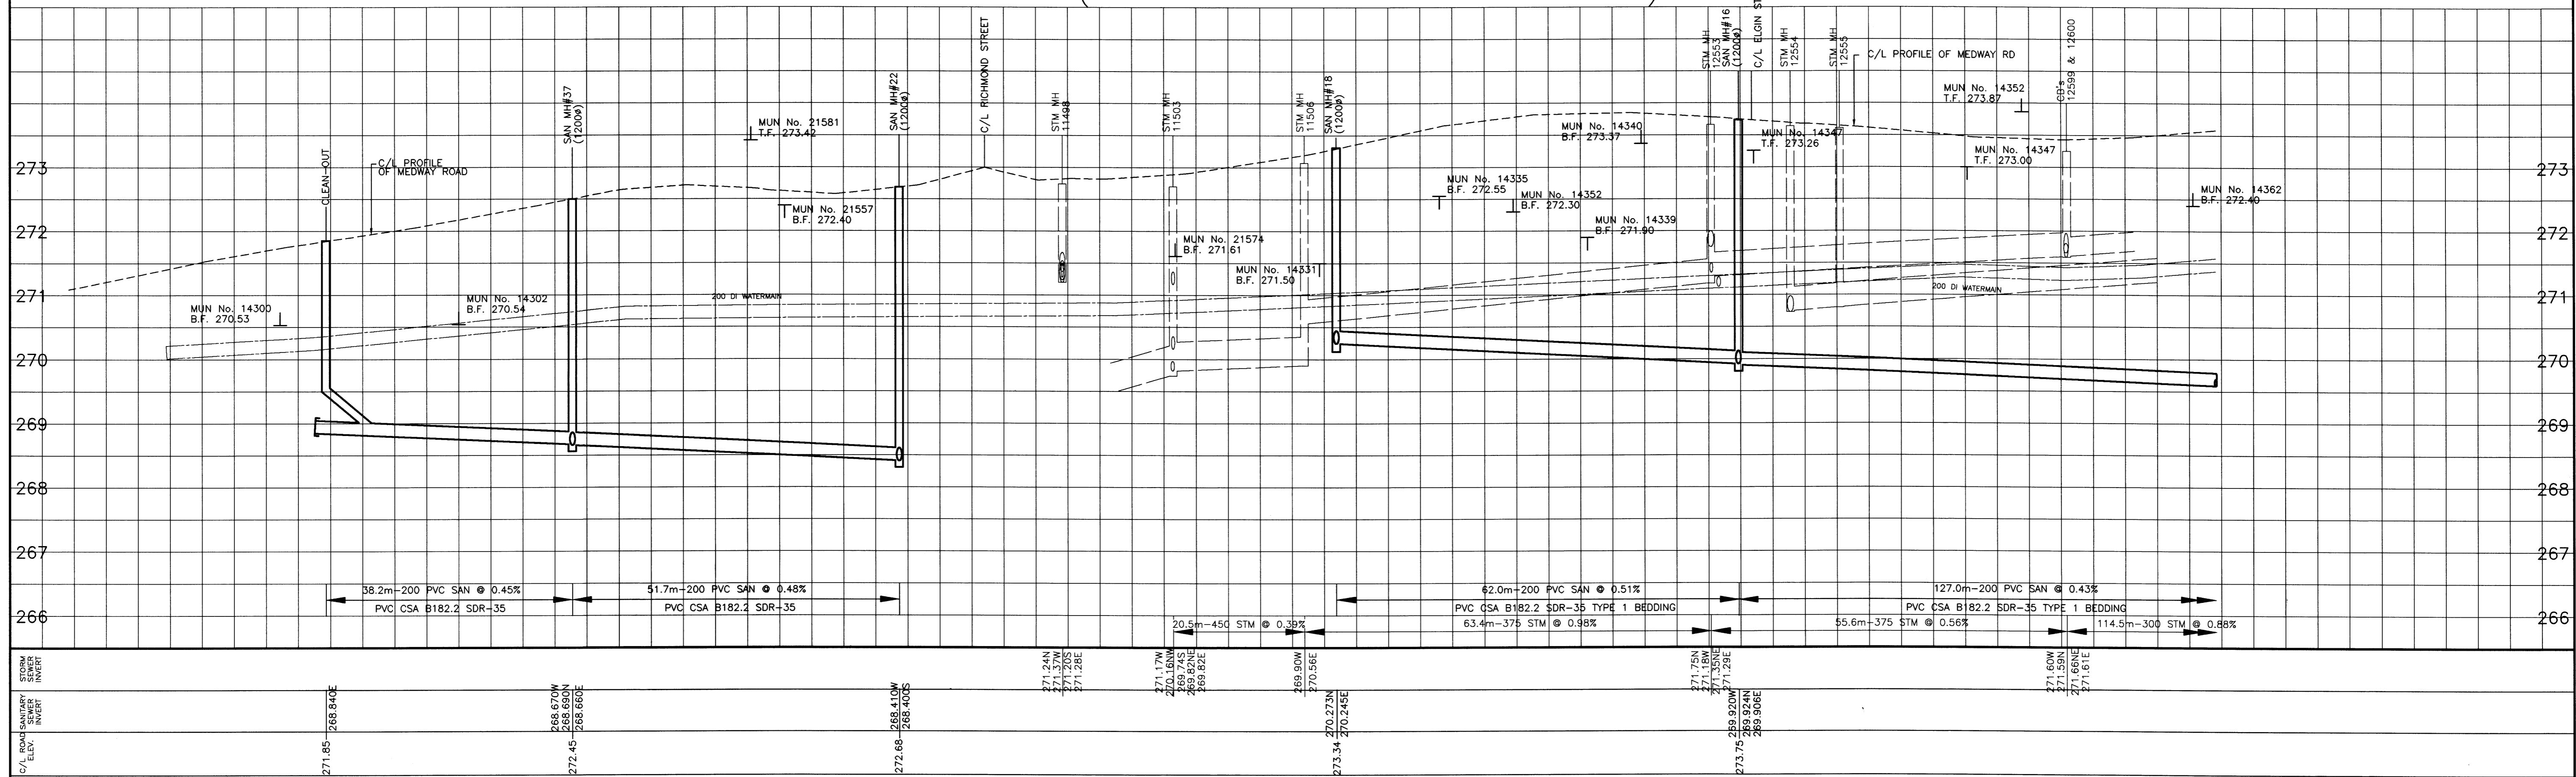


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3		CHECKED				
4		APPROVED WAB				
5		DATE APR 20/00				

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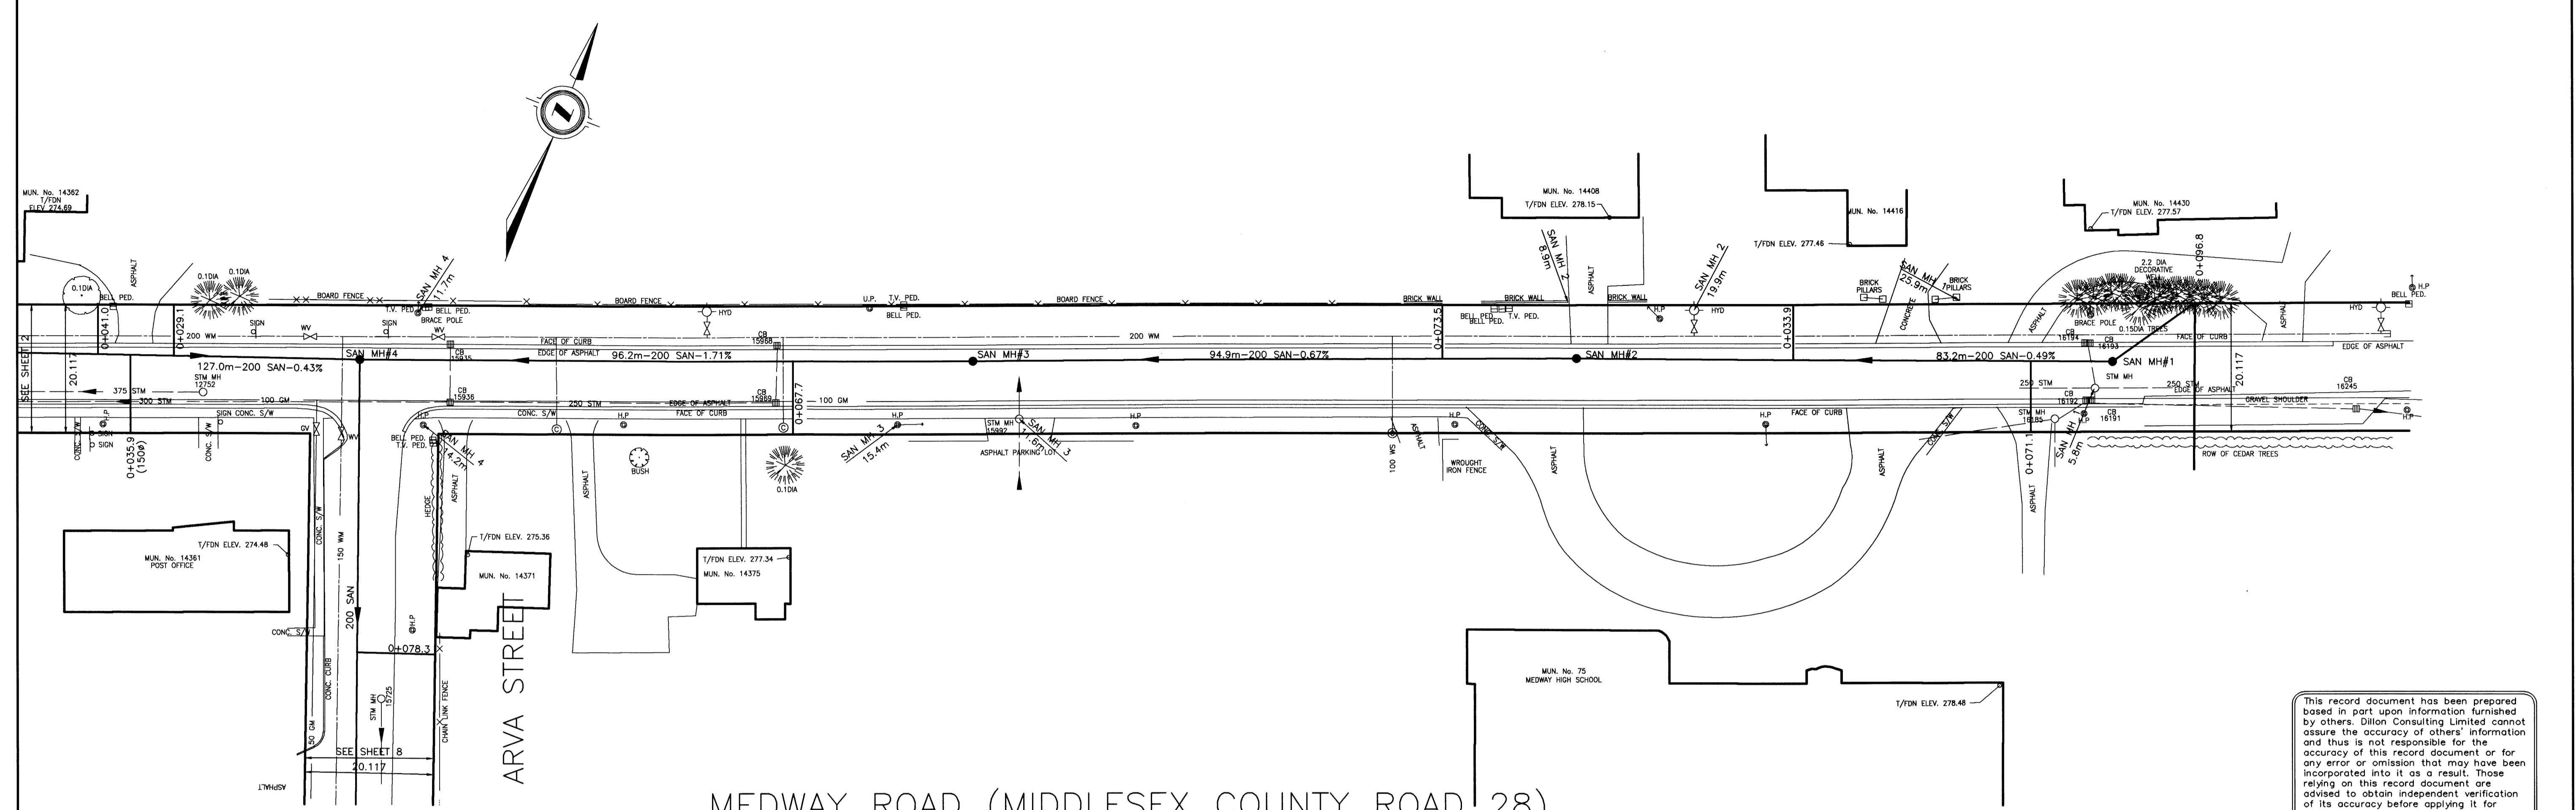


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OF  
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CENTRE


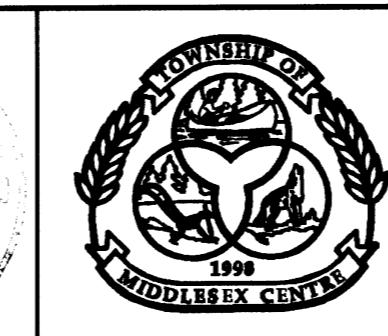
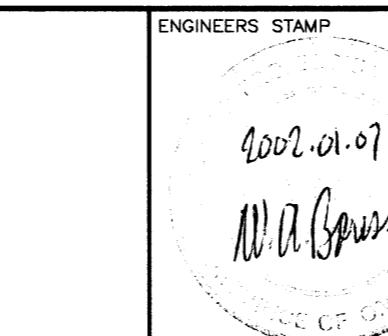


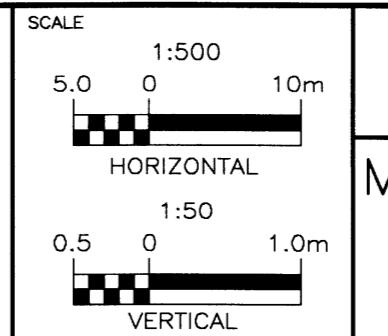ARVA SANITARY SEWAGE SYSTEM  
MEDWAY RD (MIDDLESEX CNTY RD 28)  
FROM 153m WEST OF RICHMOND STREET TO  
TO 45m WEST OF ELGIN STREET

PROJECT No  
00-7278  
SHEET No  
2  
PLAN FILE No



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CENTRE
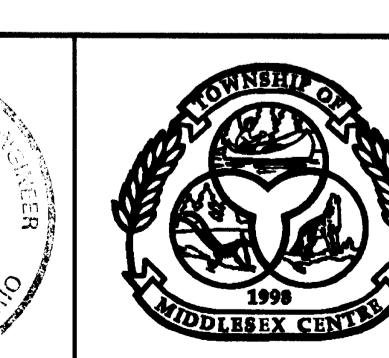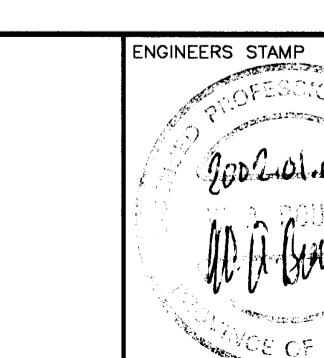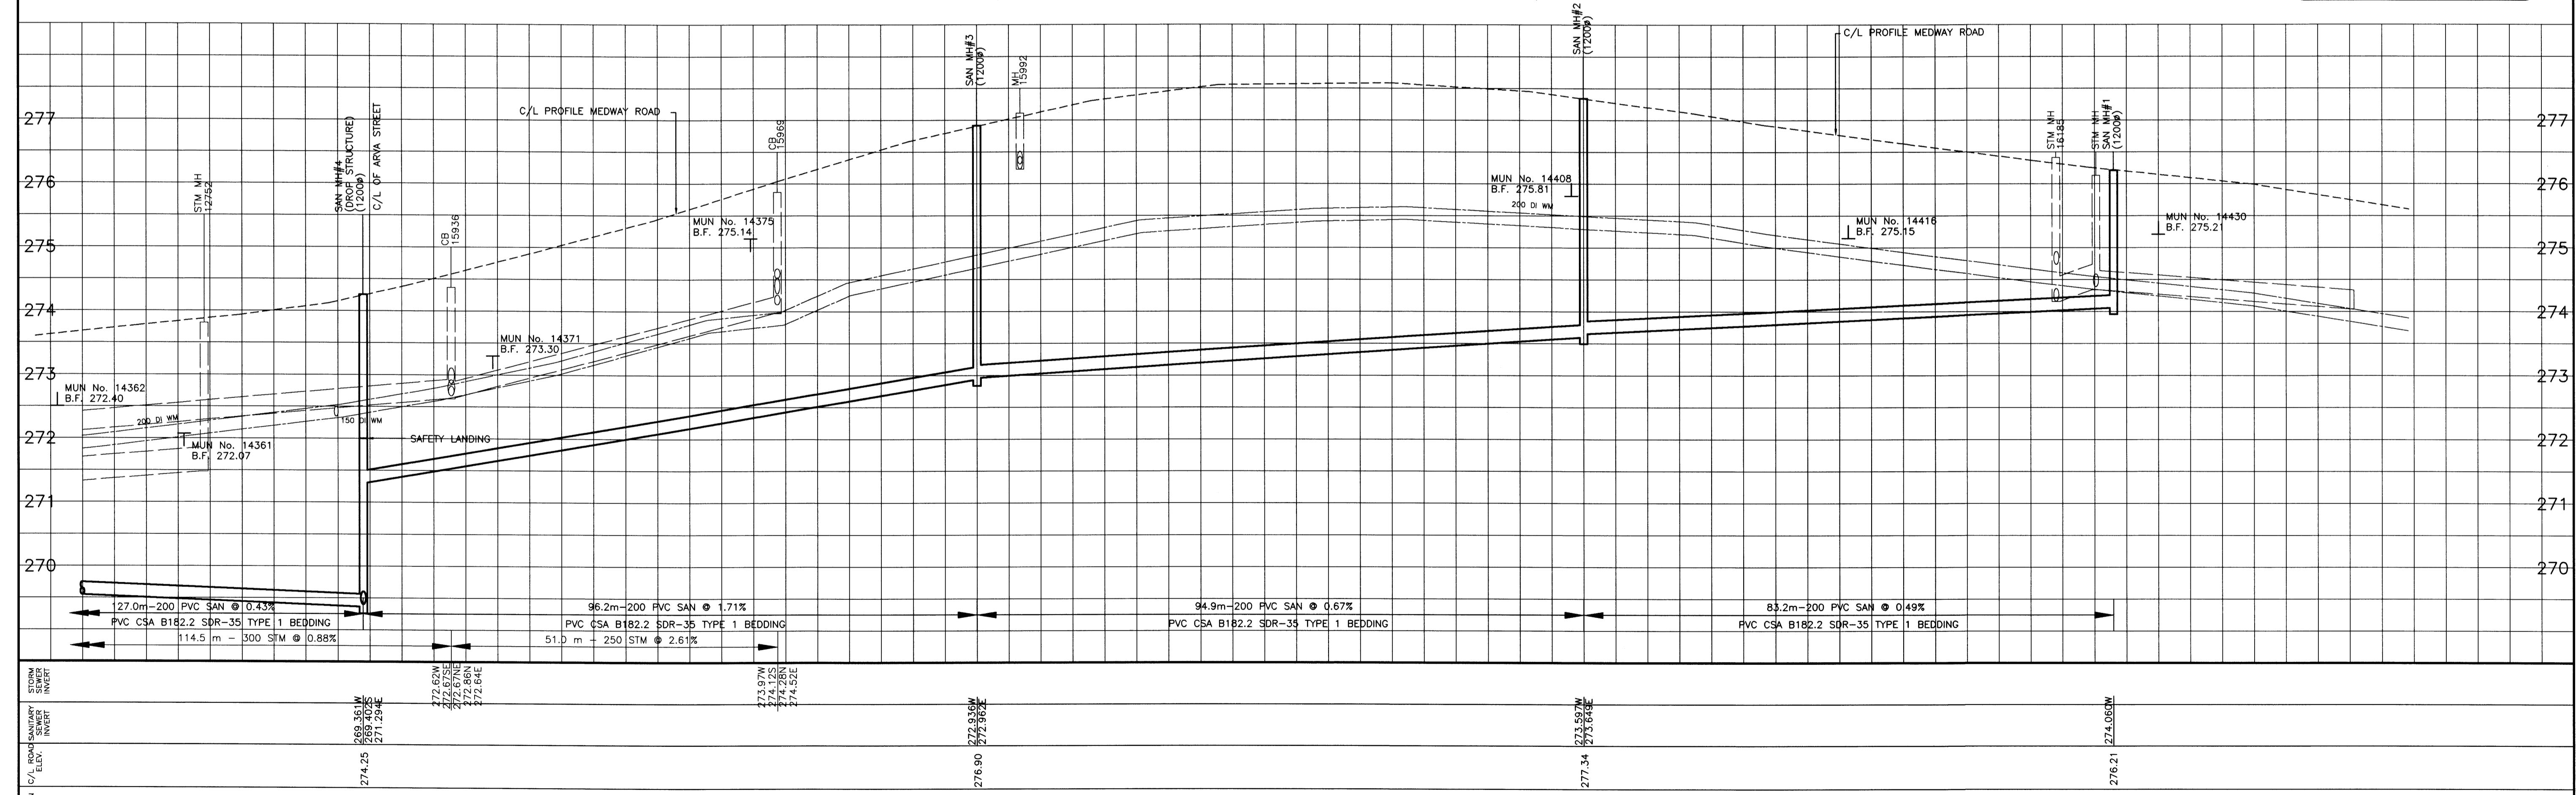
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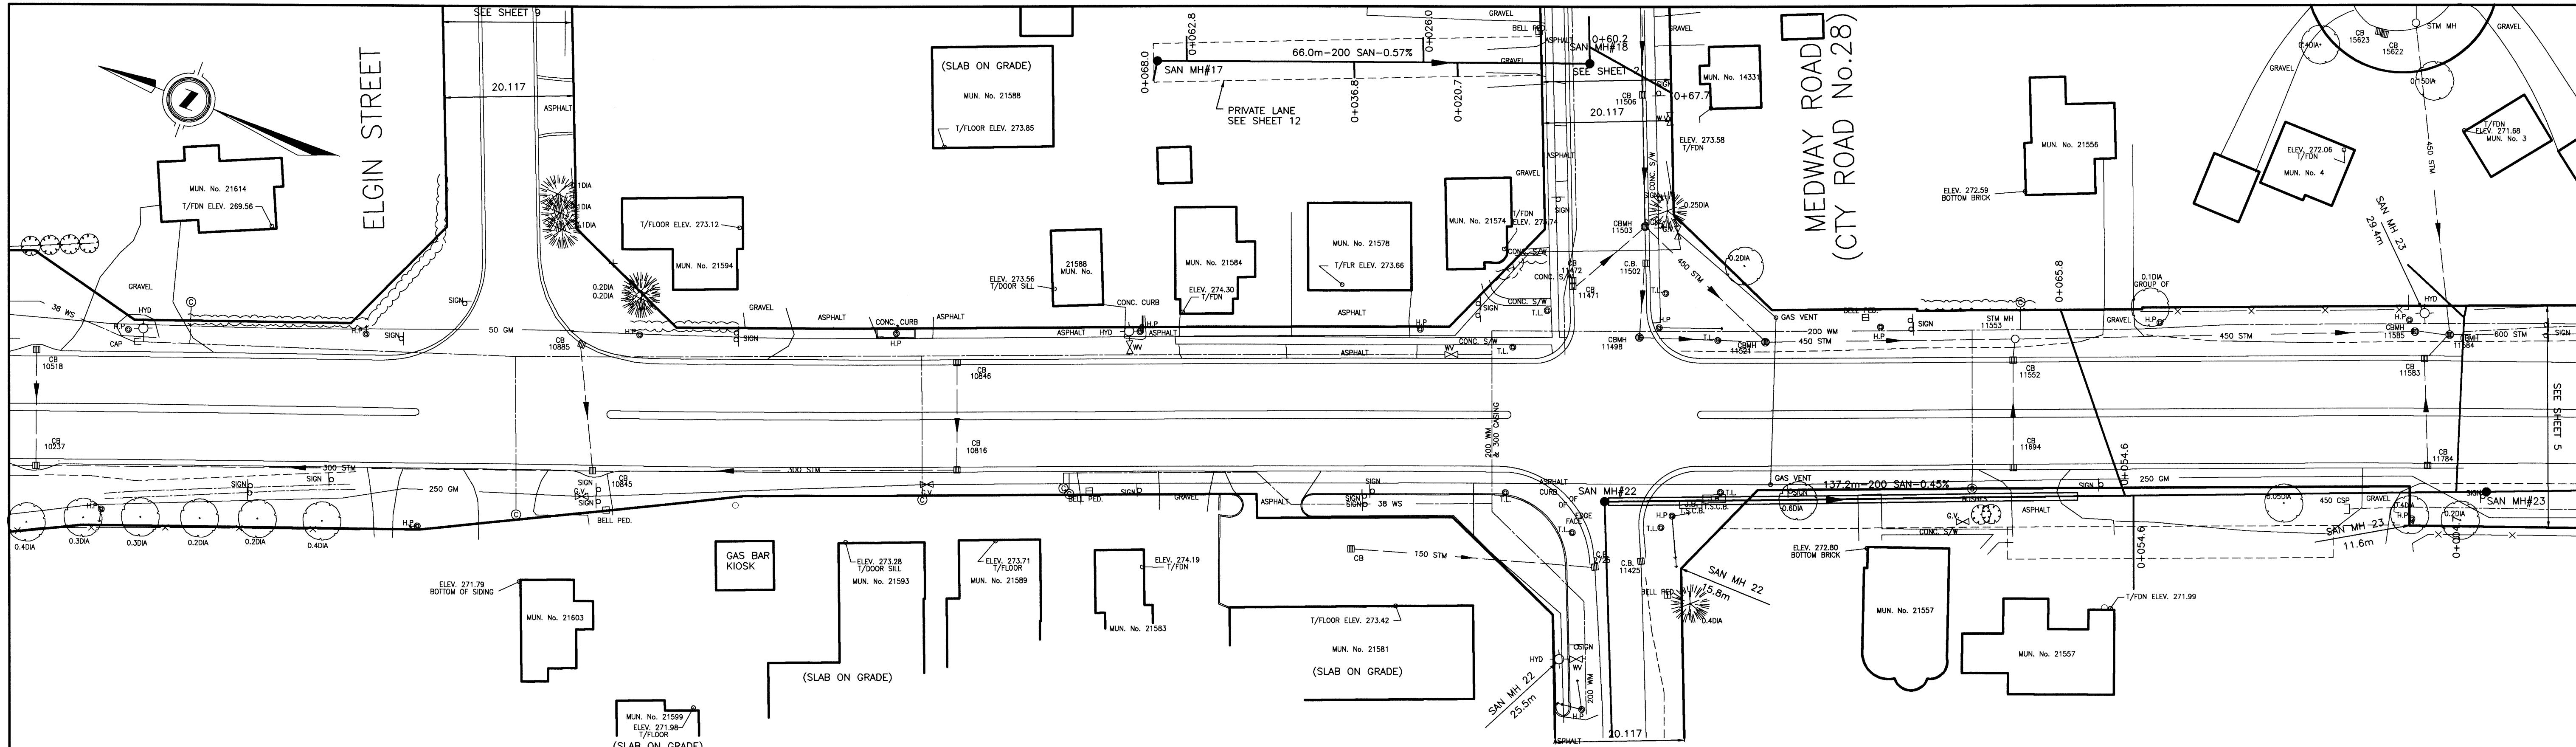
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VERTICAL

ARVA SANITARY SEWAGE SYSTEM


MEDWAY RD (MIDDLESEX CNTY RD 2  
FROM 45m WEST OF ARVA  
TO 320m EAST OF ARVA

PROJECT No	00-7278
SHEET No	3
PLAN FILE No	





# PROOF LINE ROAD - (KING'S HWY No.4)

# RICHMOND STREET – (KING'S HWY No.4)

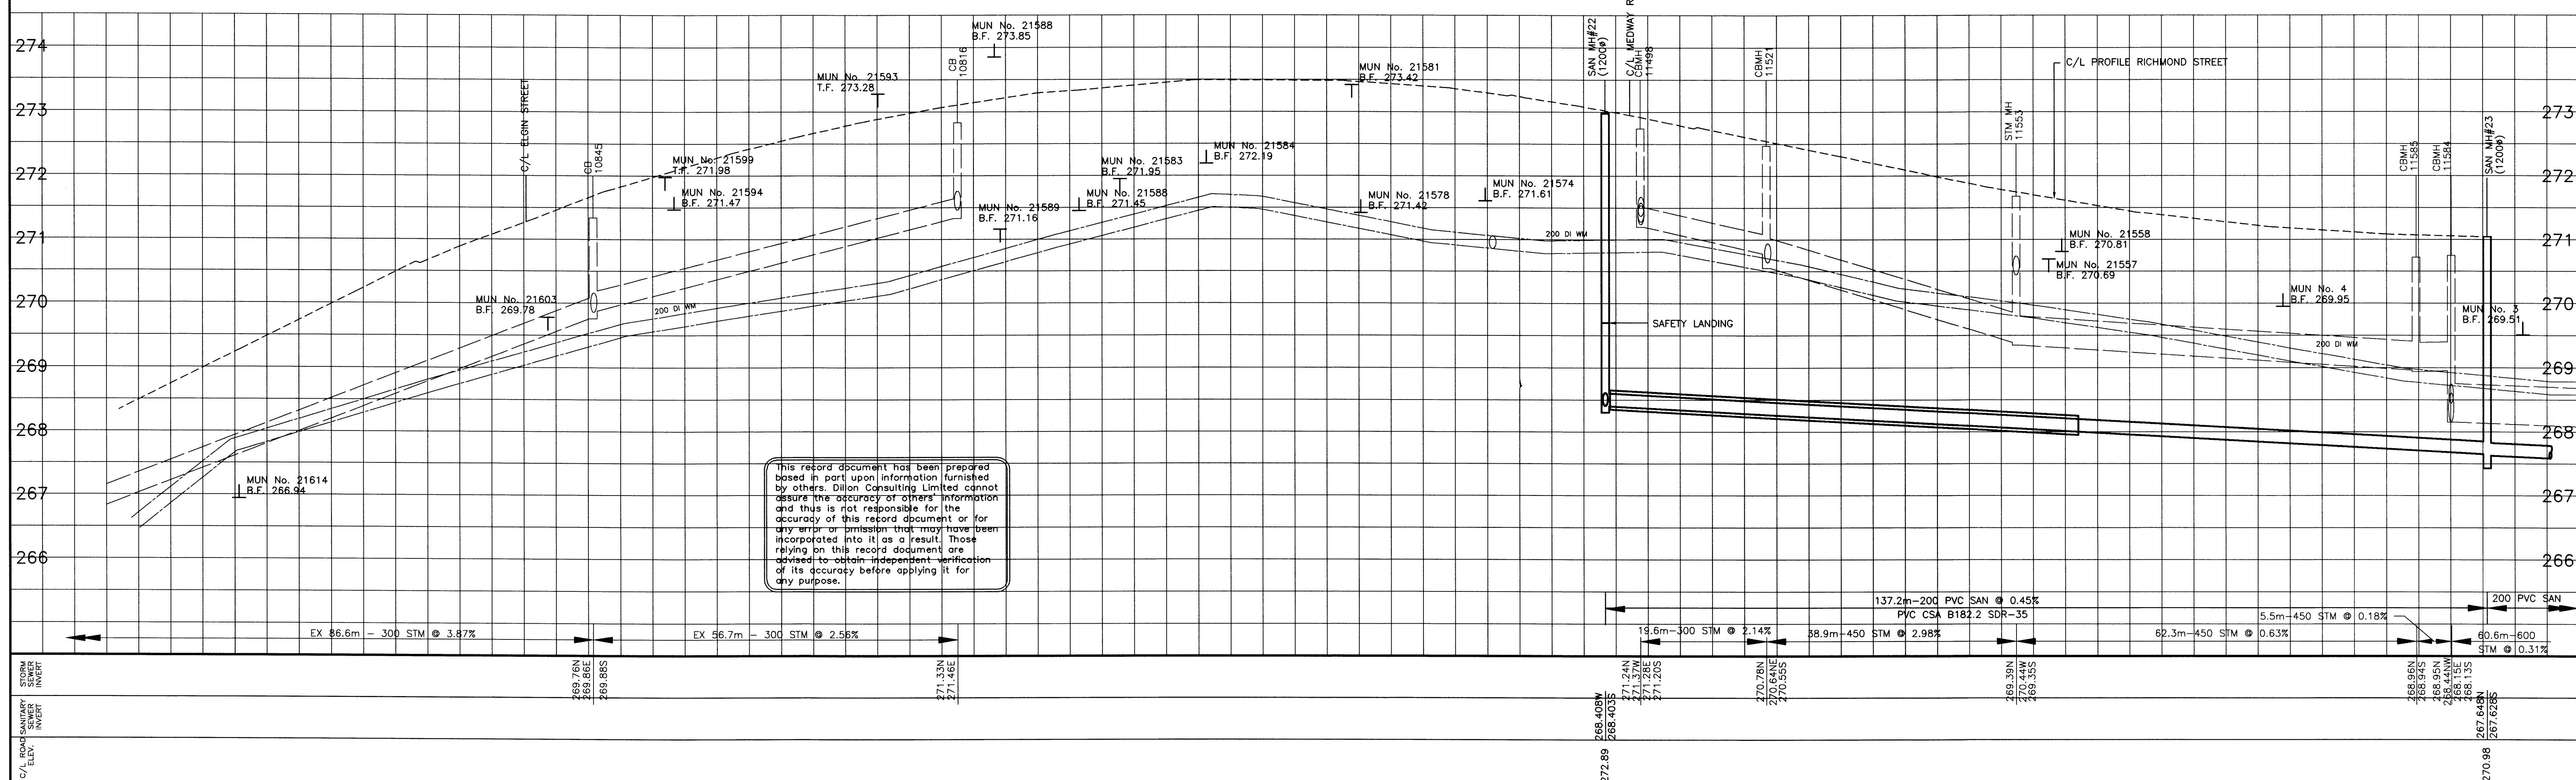

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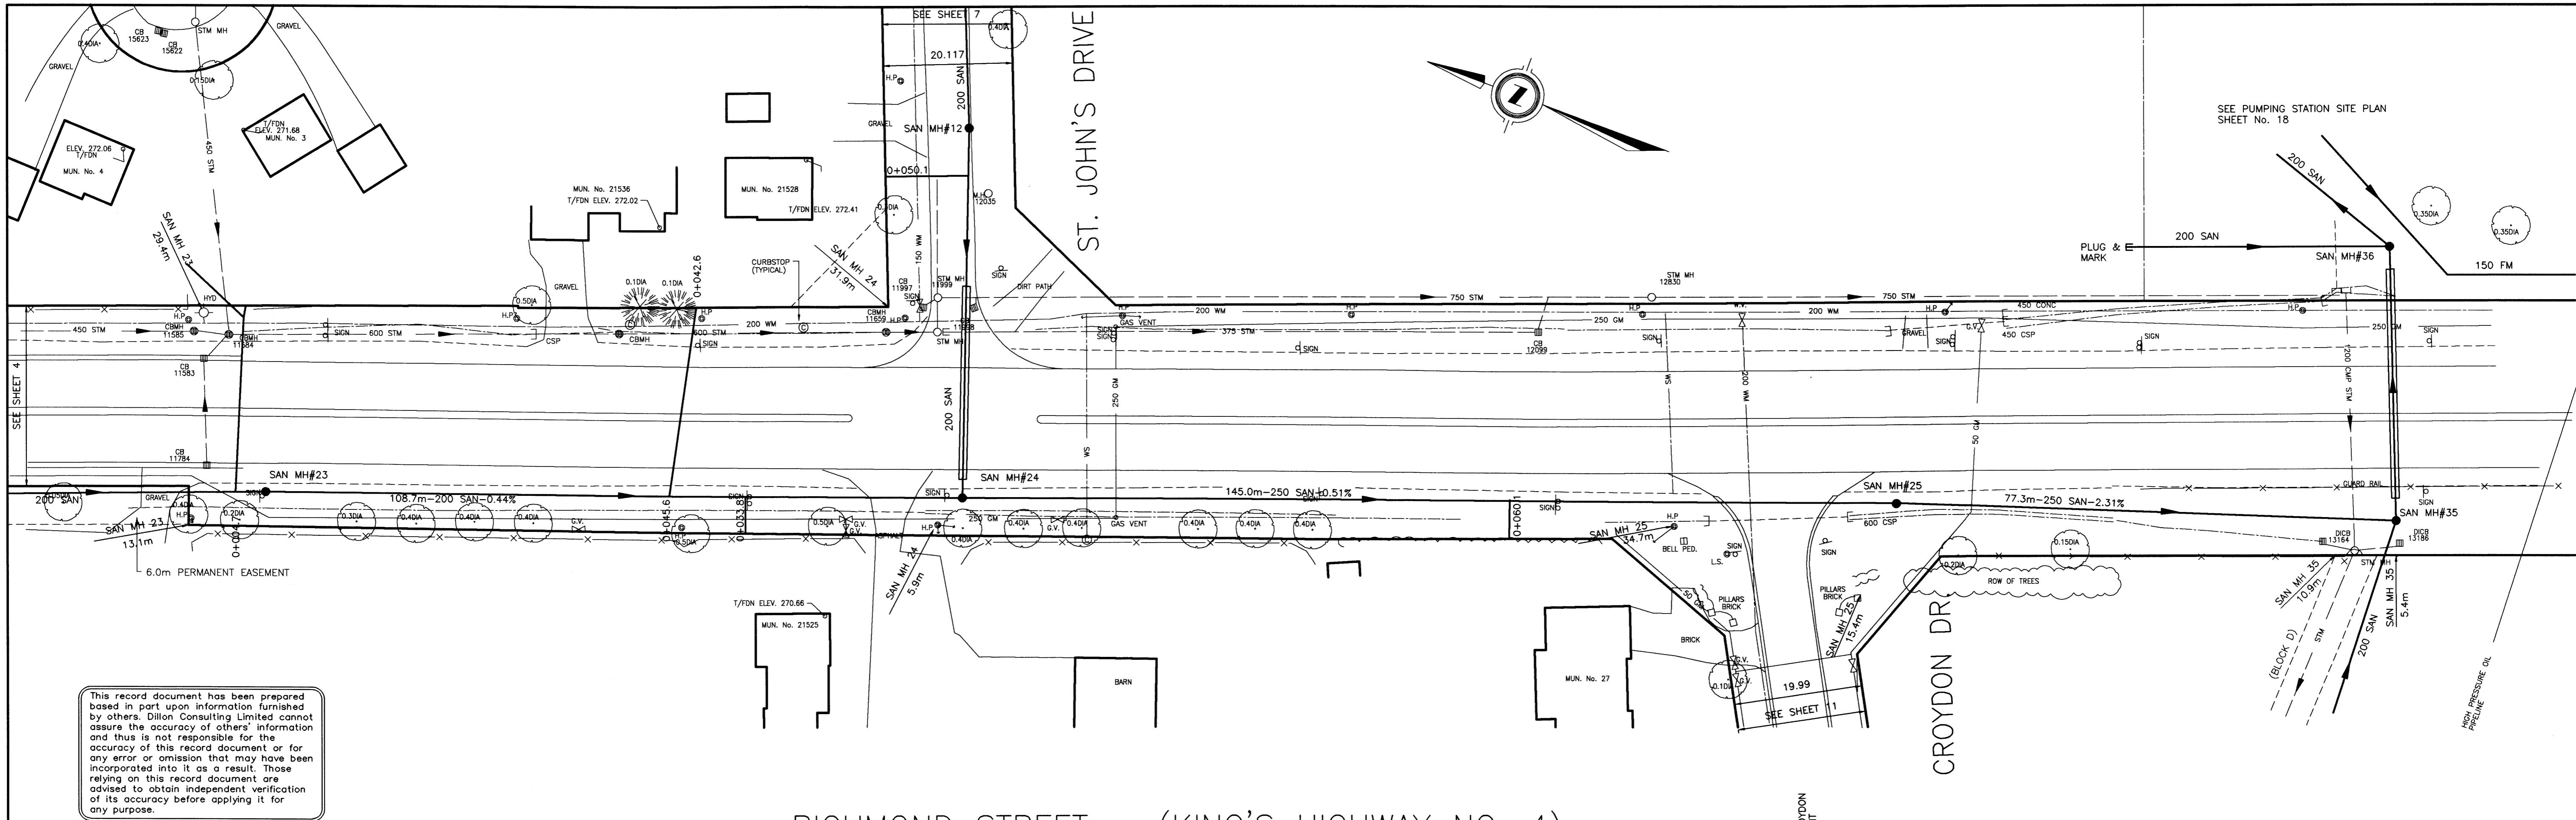
TOWNSHIP  
OF  
MIDDLESEX  
CENTRE

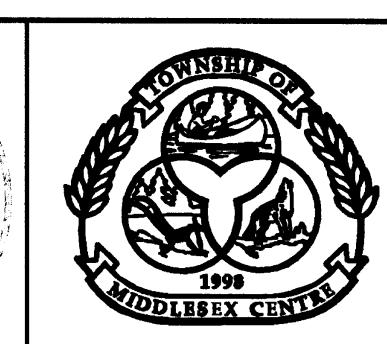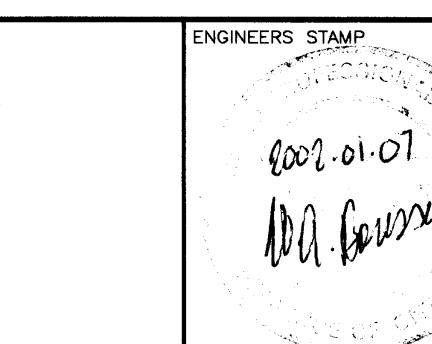ARVA SANITARY SEWAGE SYSTEM


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RICMOND ST (KING'S HWY No. 4)  
FROM 78m NORTH OF ELGIN ST TO  
151m SOUTH OF MEDWAY ROAD

PROJECT No	00-7278
SHEET No	4
PLAN FILE No	





RICHMOND STREET – (KING'S HIGHWAY NO. 4)

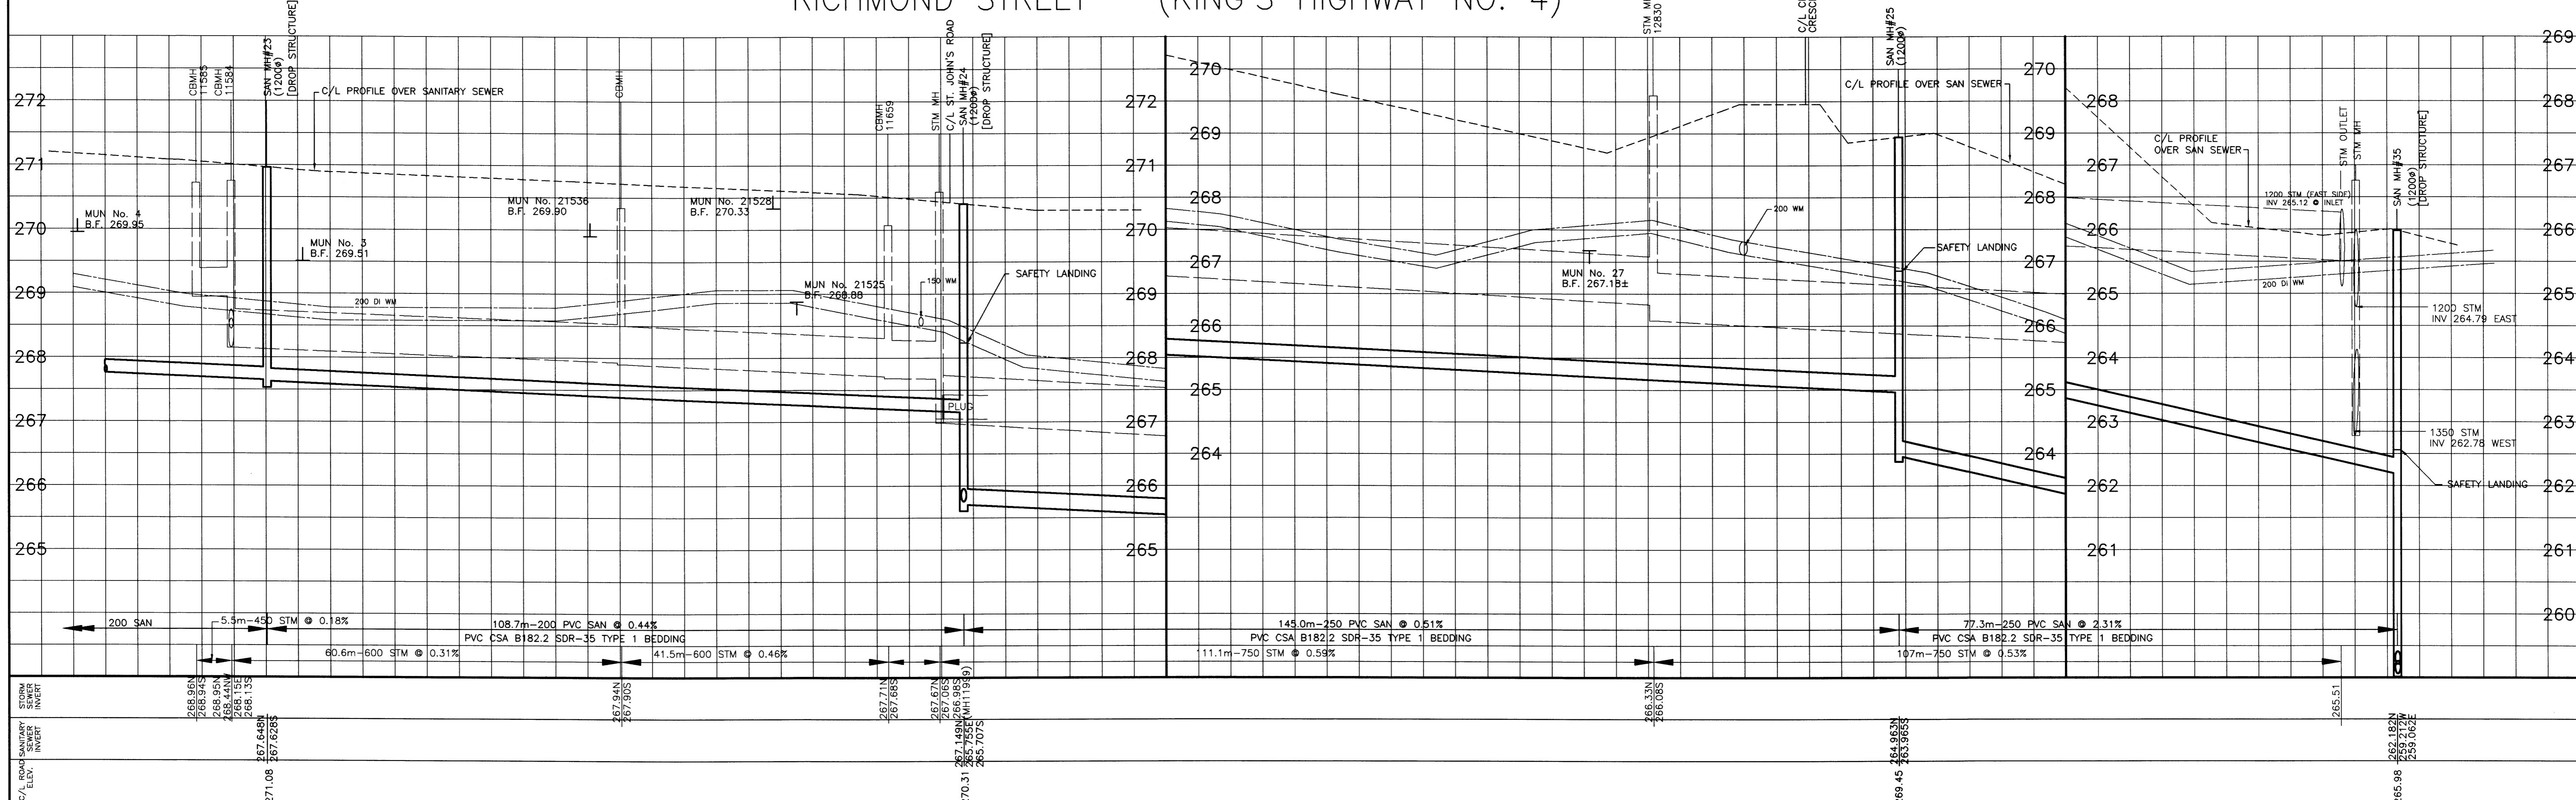

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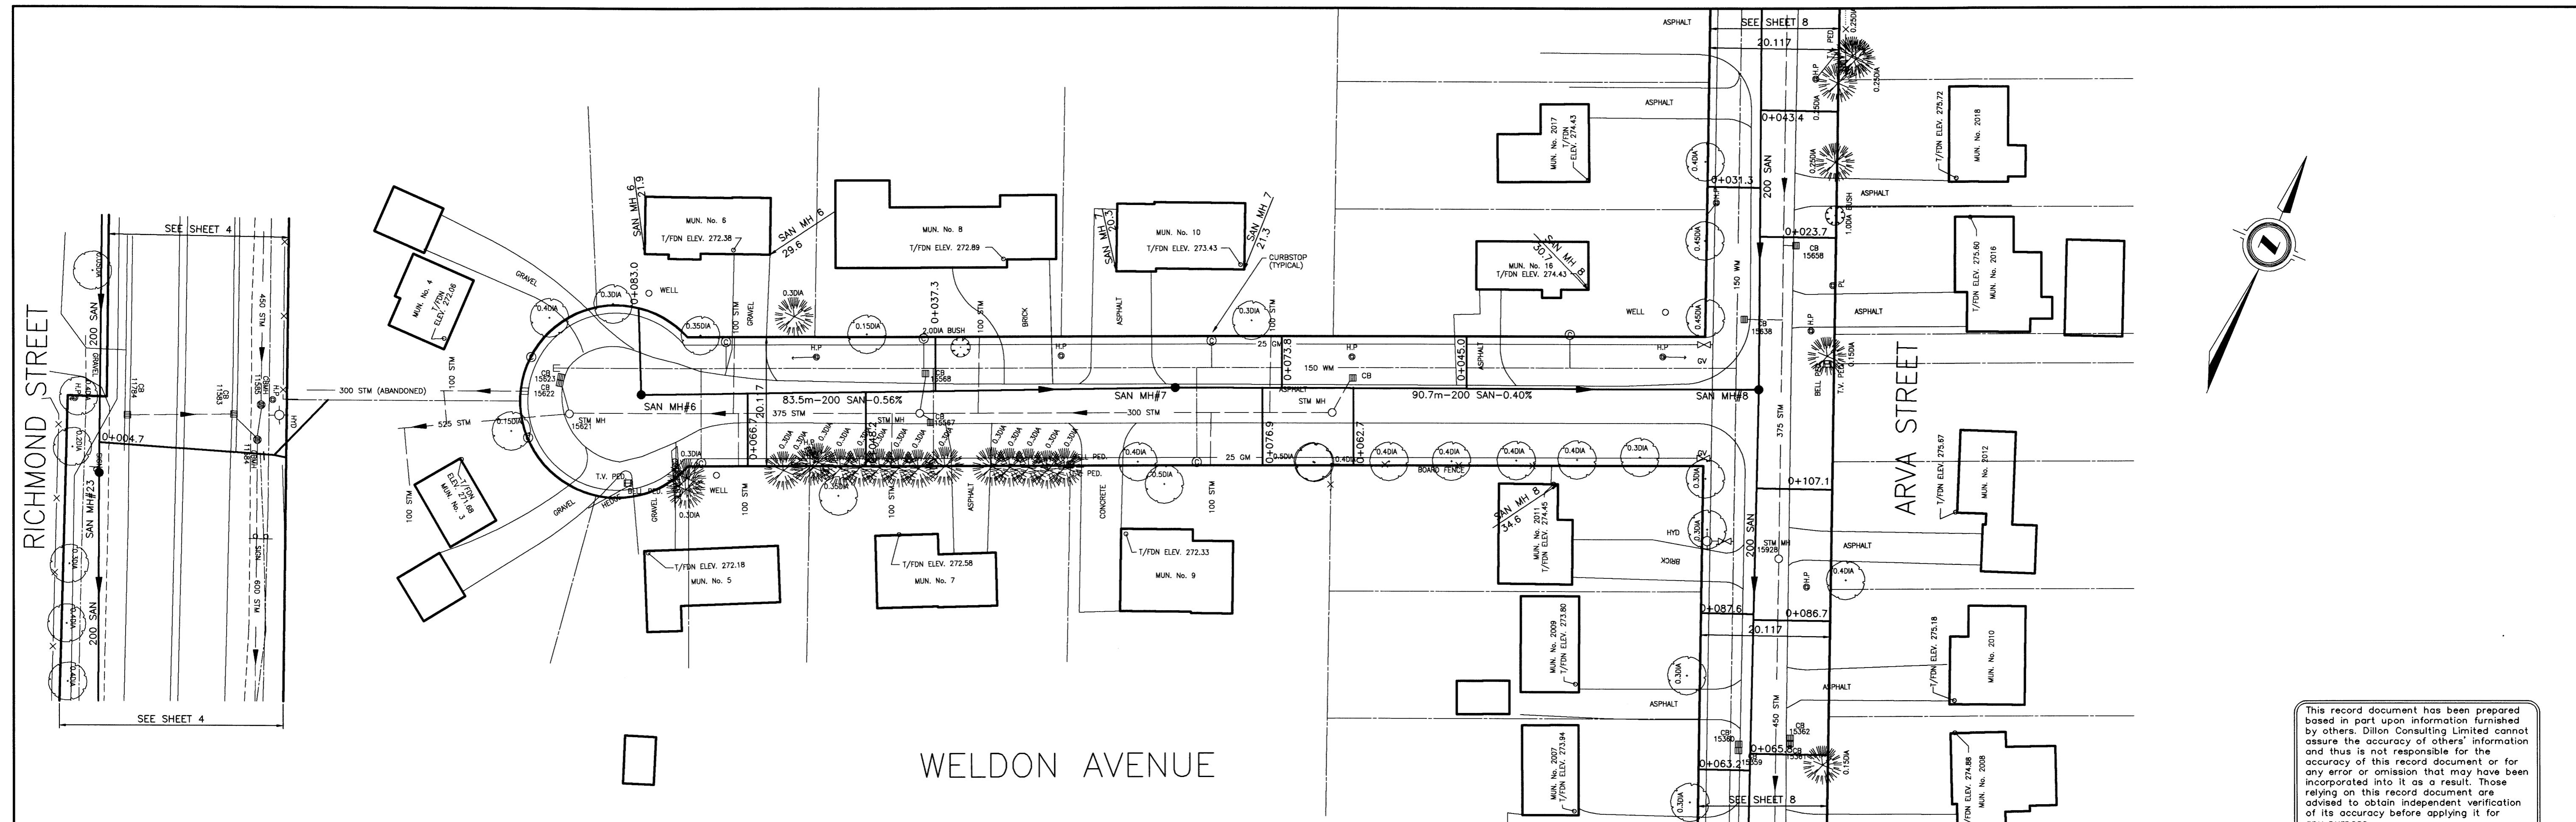


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OF  
MIDDLESEX  
CENTRE

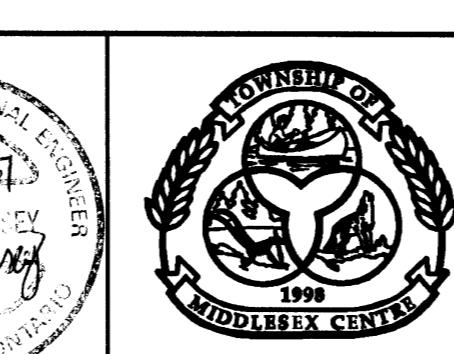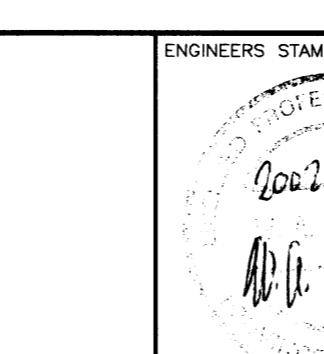
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HORIZONTAL  
0.5 0 1.0m  
VERTICAL

ARVA SANITARY SEWAGE SYSTEM  
RICHMOND ST (KING'S HWY No. 4)  
FROM 145m NORTH OF ST. JOHN'S DRIVE TO  
125m SOUTH OF CROYDON DRIVE

PROJECT No  
00-7278  
SHEET No  
5  
PLAN FILE No



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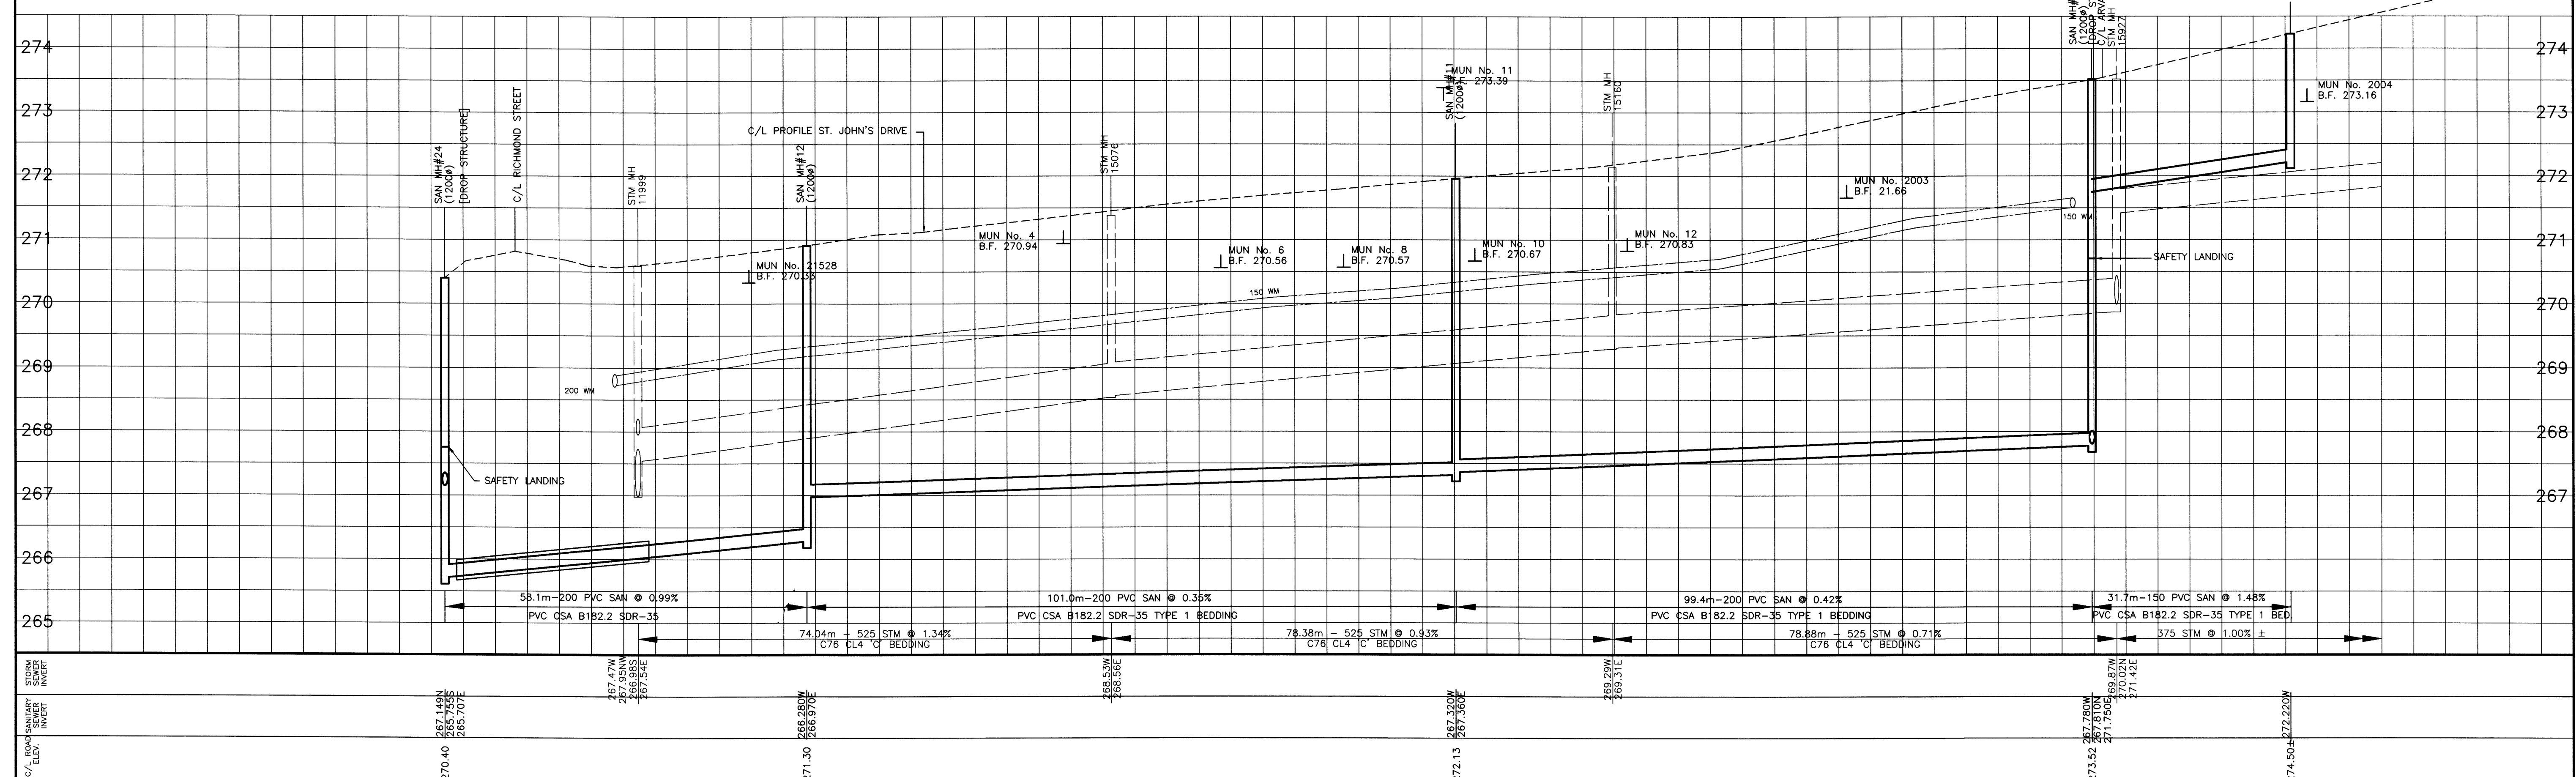
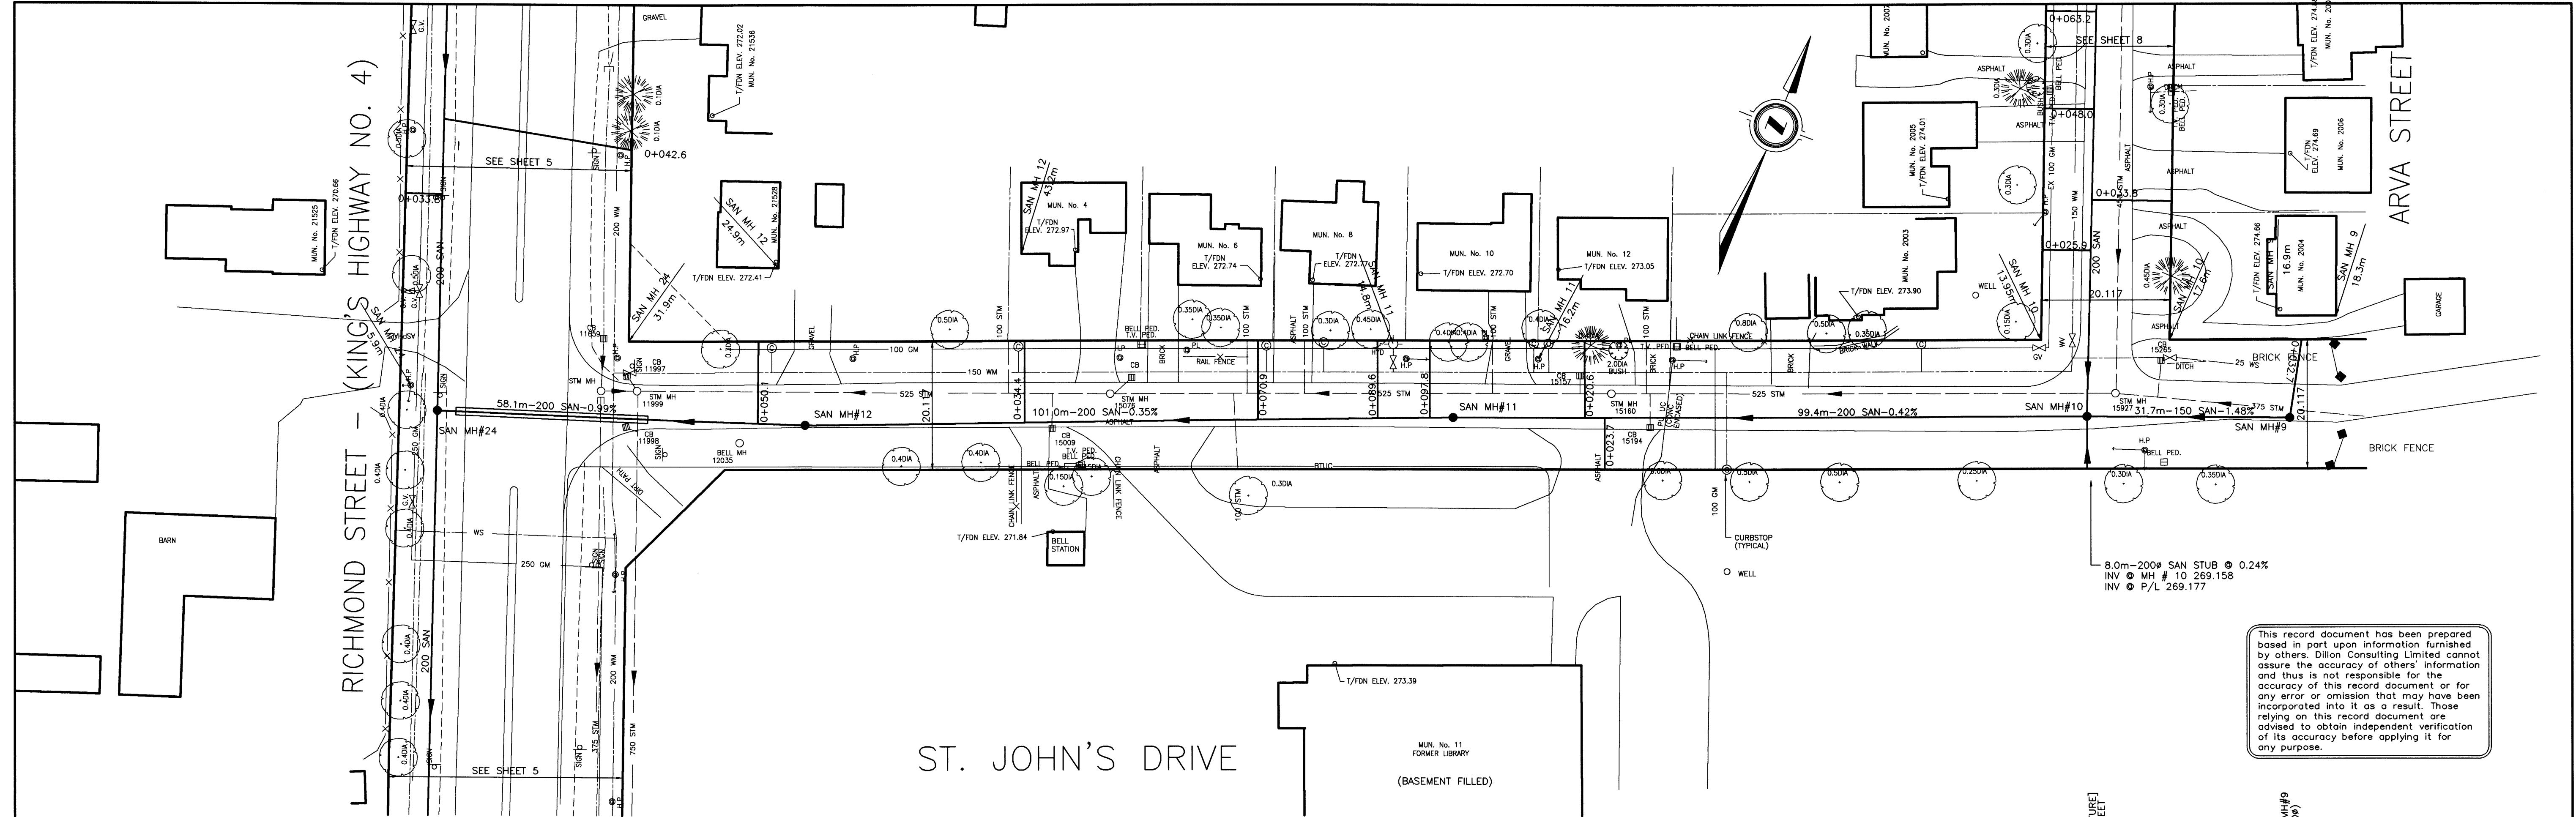
TOWNSHIP  
OF  
MIDDLESEX  
CENTRE

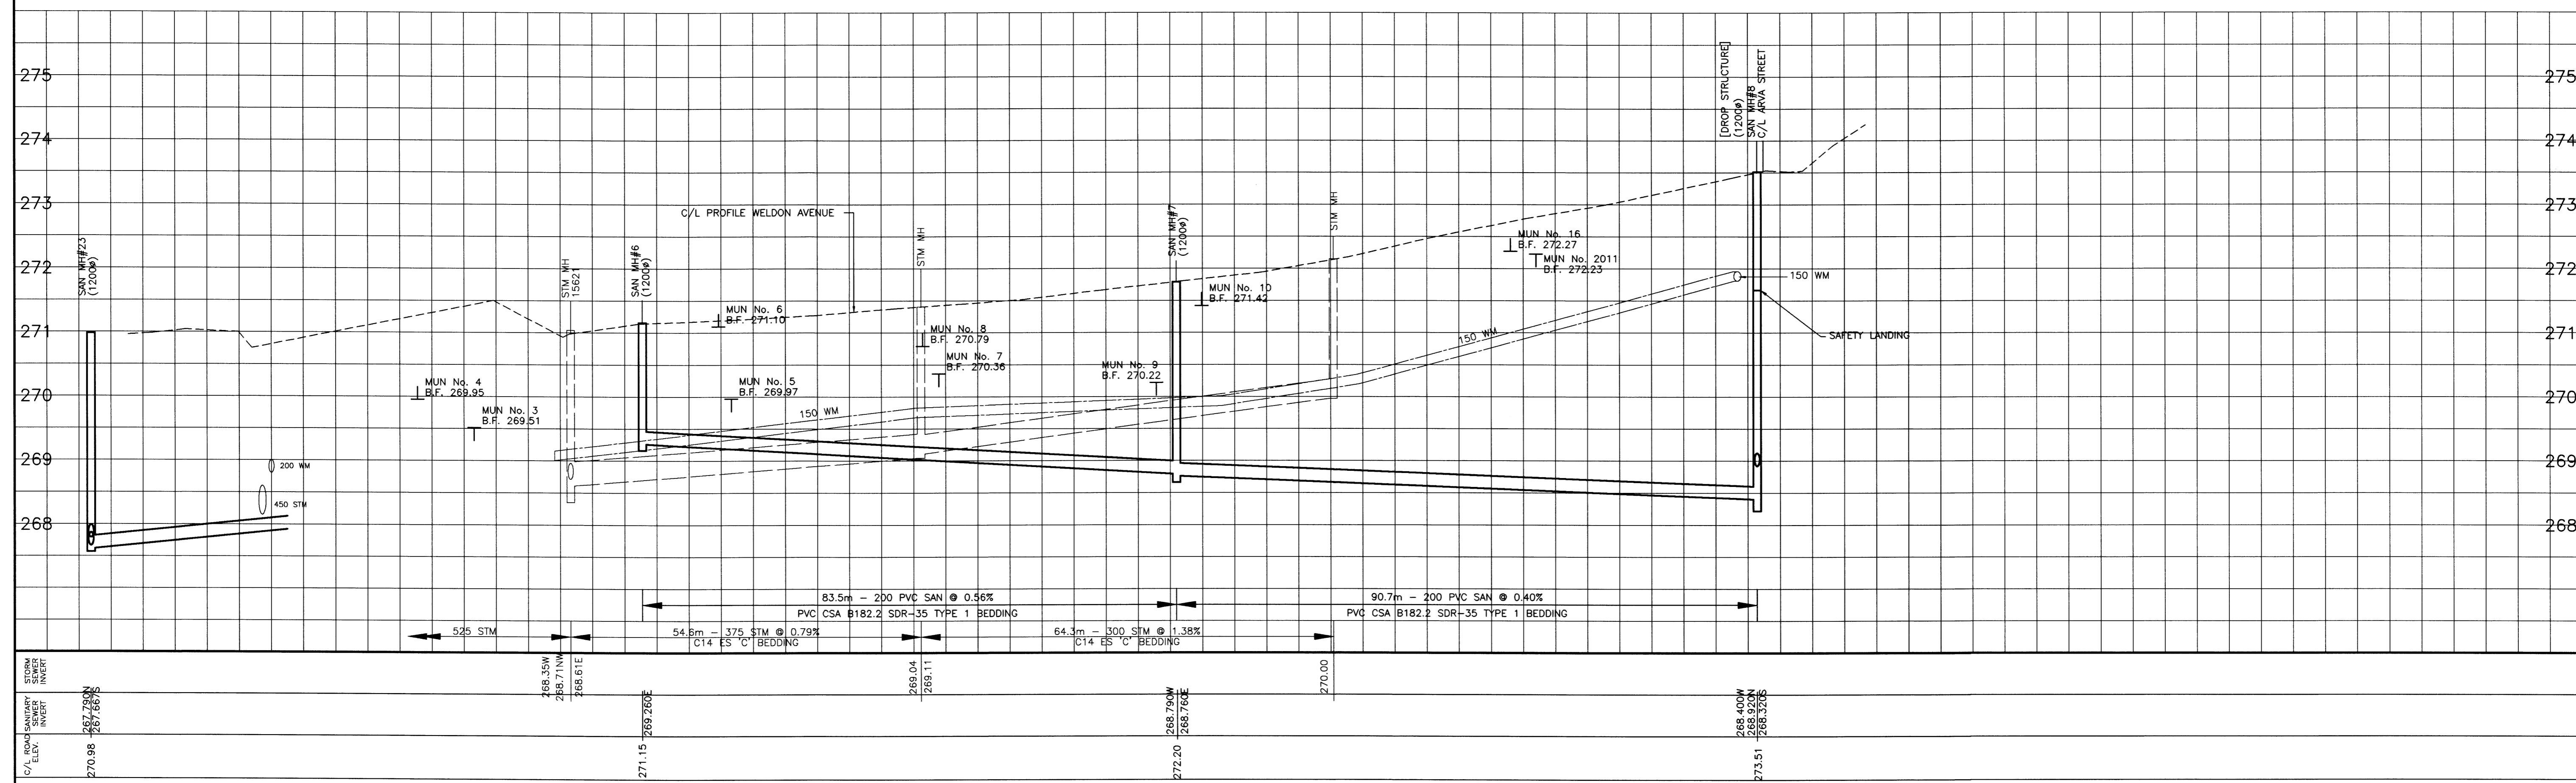ARVA SANITARY SEWAGE SYSTEM

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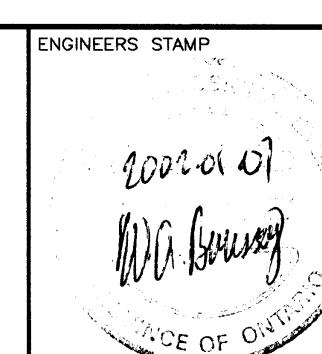
WELDON AVENUE  
FROM RICHMOND STREET TO ARVA STREET

PROJECT No  
00-7278  
SHEET No  
6  
PLAN FILE No




AS CONSTRUCTED NOTES	AS CONSTRUCTED SERVICES	COMPLETION	REVISIONS	DATE	BY
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2	DRAWN EMB				
3	CHECKED WAB				
4	APPROVED				
5	DATE APR 20/00				

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**TOWNSHIP  
OF  
MIDDLESEX  
CENTRE**




**ARVA SANITARY SEWAGE SYSTEM  
ST. JOHN'S DRIVE  
FROM RICHMOND STREET TO ARVA STREET**

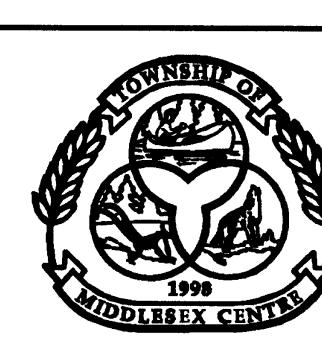**PROJECT No  
00-7278**


**SHEET No  
7**

**PLAN FILE No**


MEDWAY ROAD = (MIDDLESEX CNTY RD NO. 28)

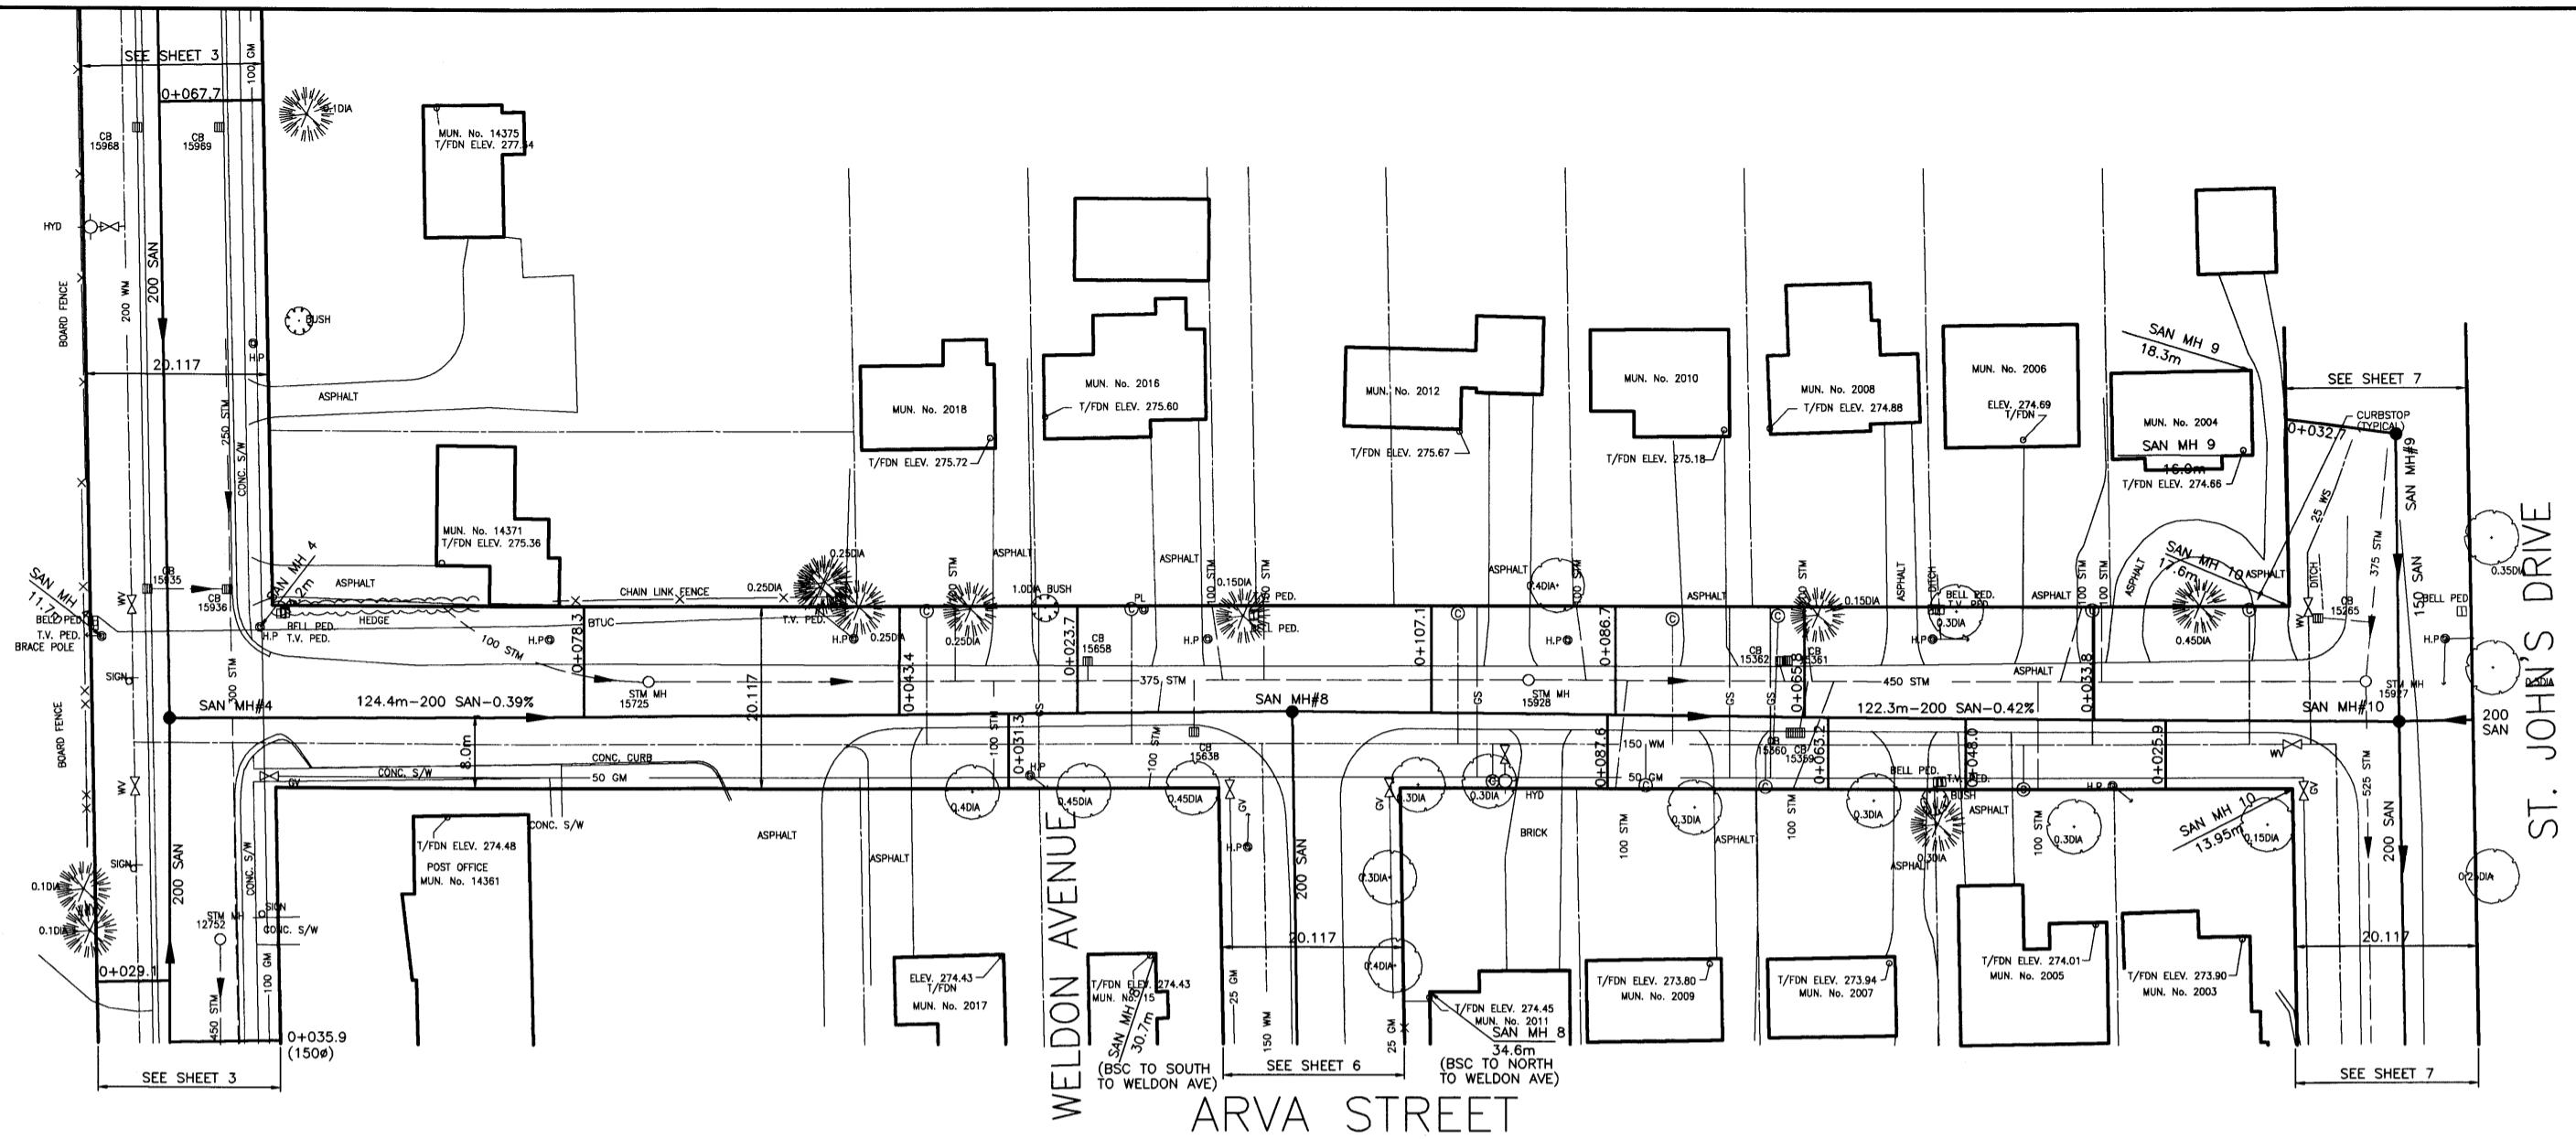

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AS CONSTRUCTED NOTES	AS CONSTRUCTED SERVICES	COMPLETION	No	REVISIONS
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2		DRAWN EMB		
3		CHECKED WAB		
4		APPROVED		
5		DATE APR 20/00		

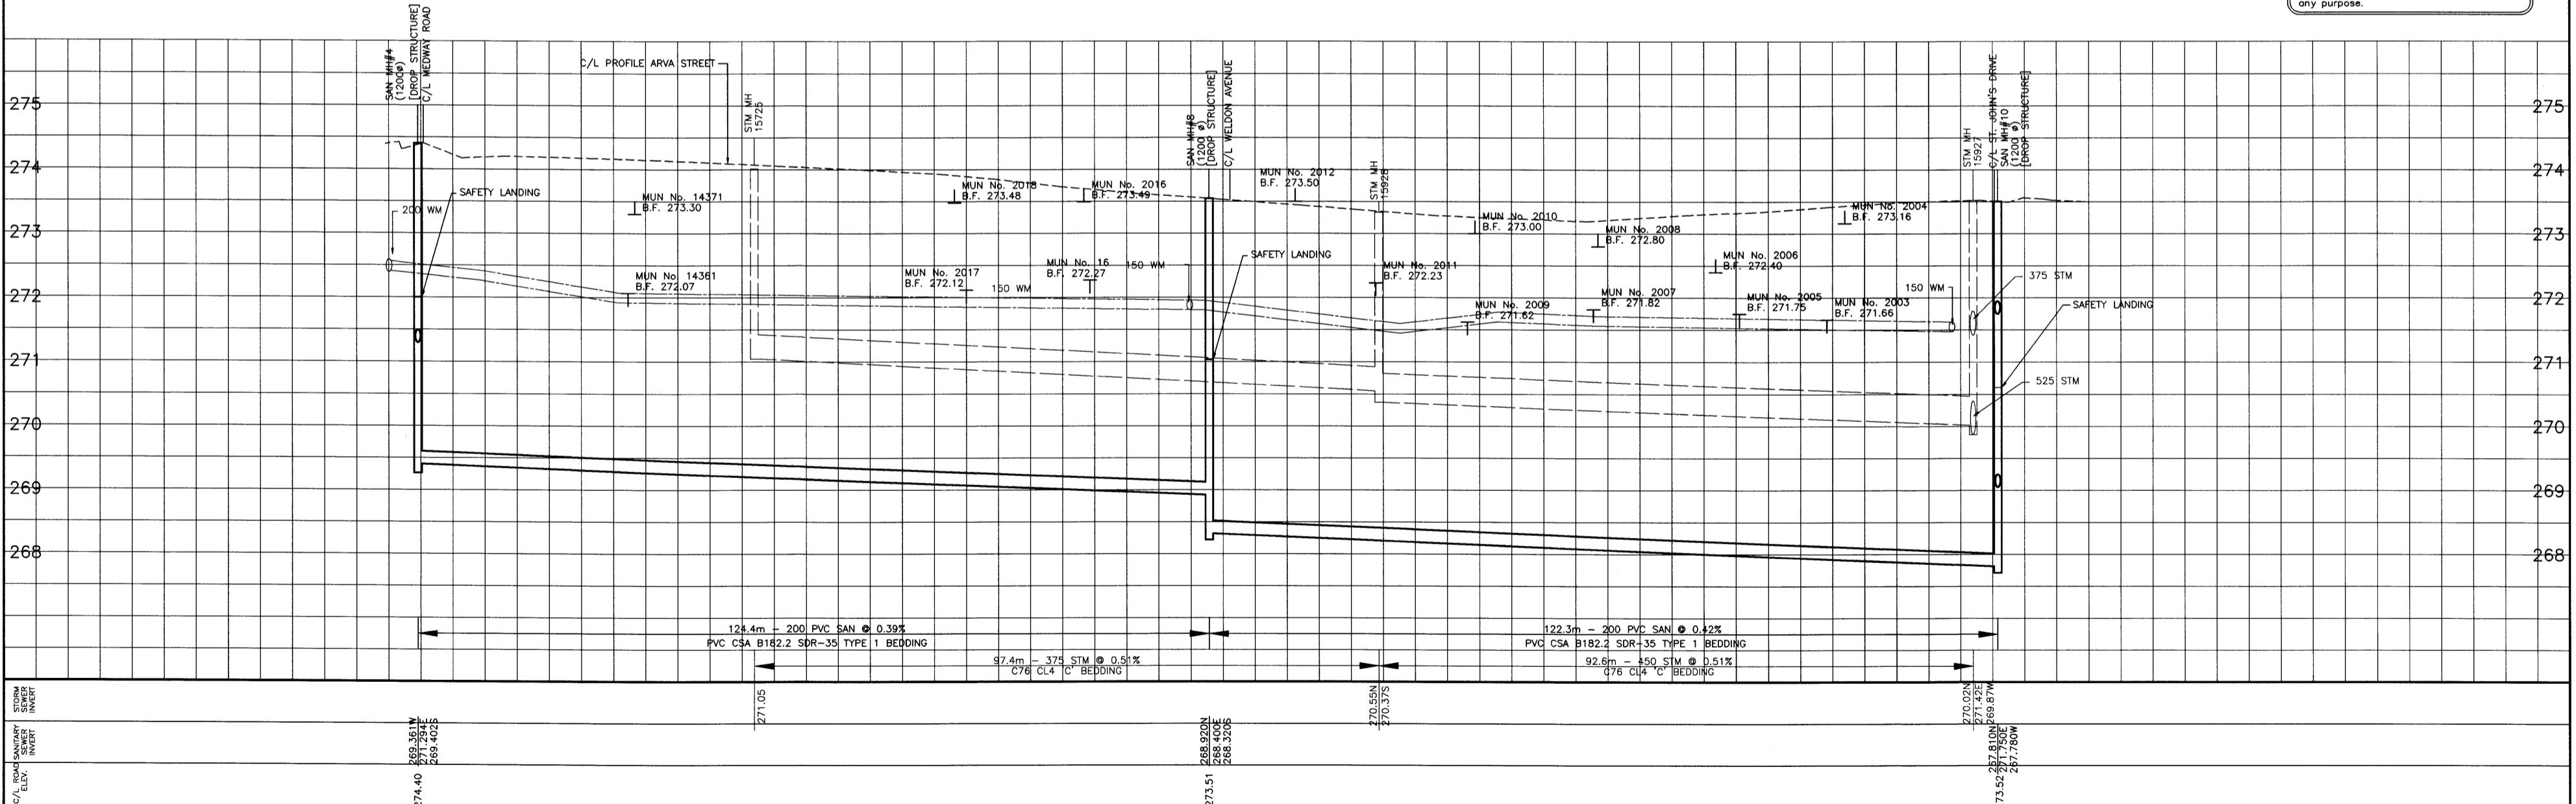

TOWNSHIP  
OF  
MIDDLESEX  
CENTRE

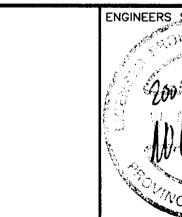
ARVA SANITARY SEWAGE SYSTEM

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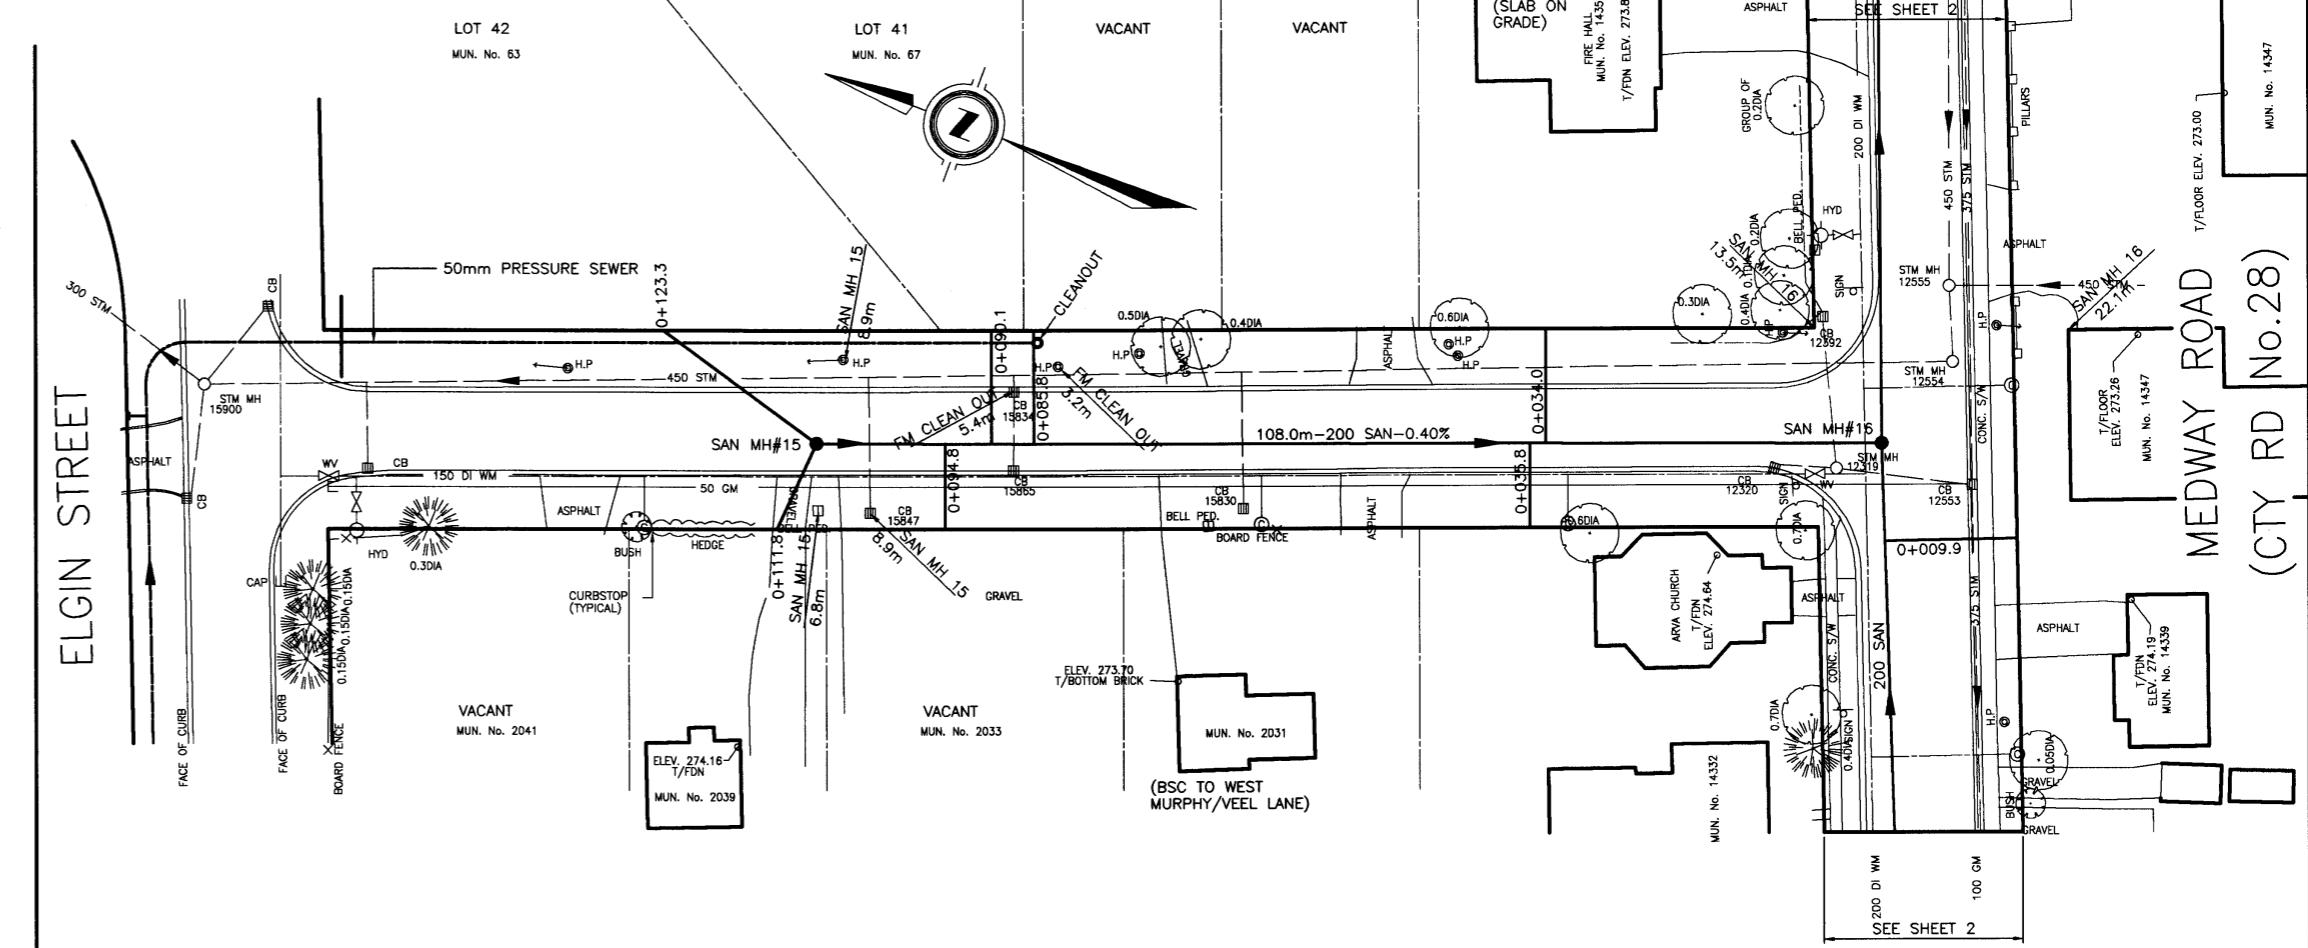
ARVA STREET  
FROM MEDWAY ROAD TO ST. JOHN'S DRIVE

PROJECT No	00-7278
HEET No	8
LAN FILE No	

PROOF LINE ROAD - (KING'S HIGHWAY NO. 4)

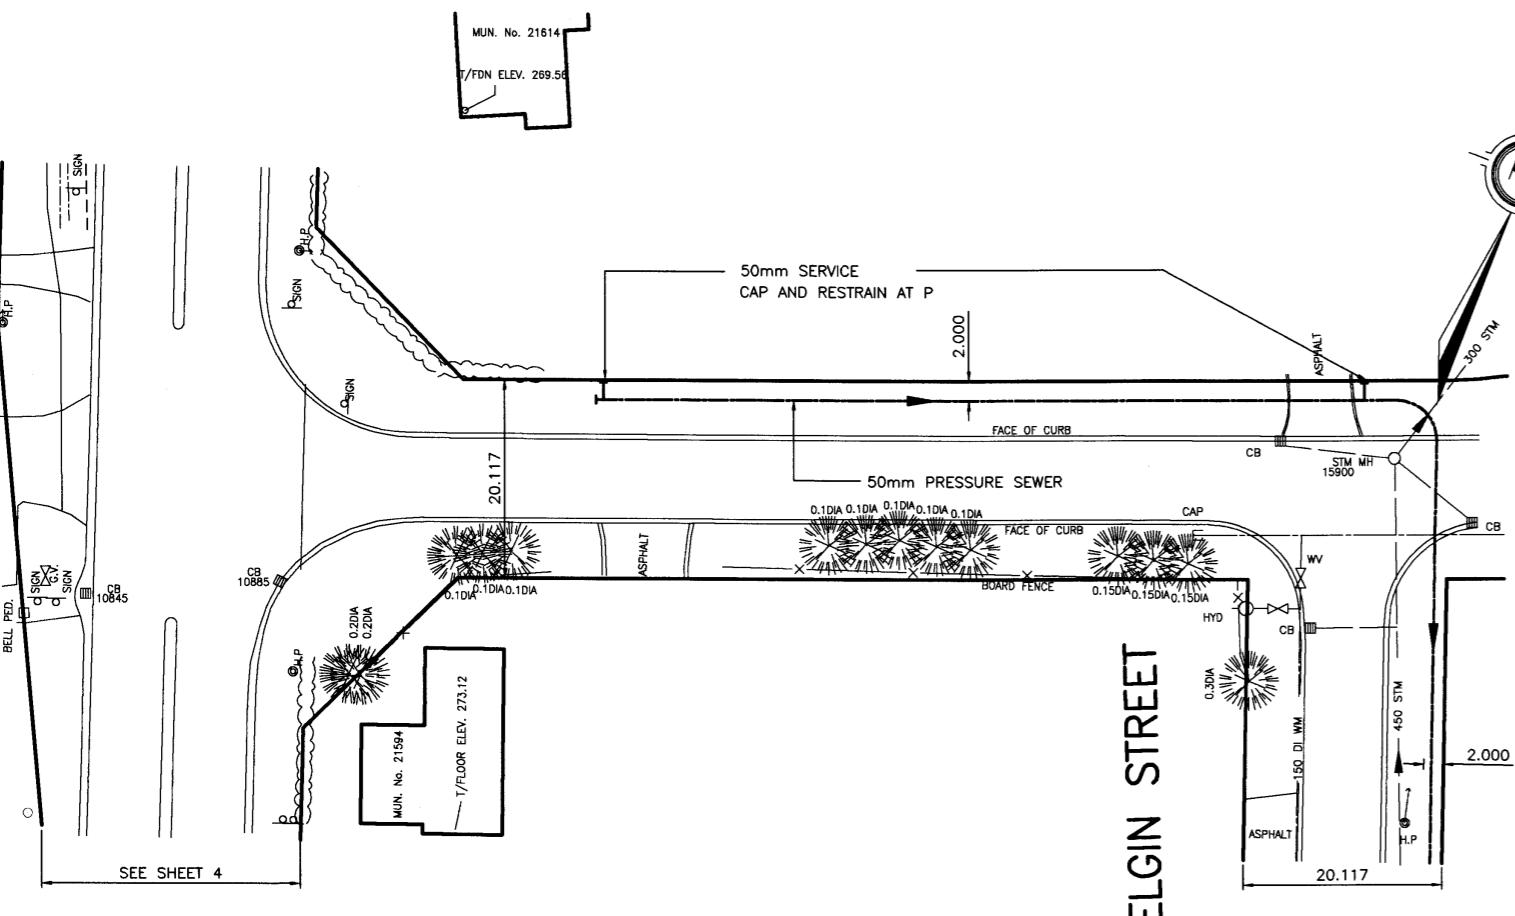


ELGIN STREET





ELGIN STREET

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AS CONSTRUCTED NOTES	AS CONSTRUCTED SERVICES	COMPLETION	No.	REVISIONS	DATE	BY
1	DESIGN R.J.M	1		AS CONSTRUCTED	NOV/01	WAB
2	DRAWN EMB					
3	CHECKED WAB					
4	APPROVED					
5	DATE APR 20/00					

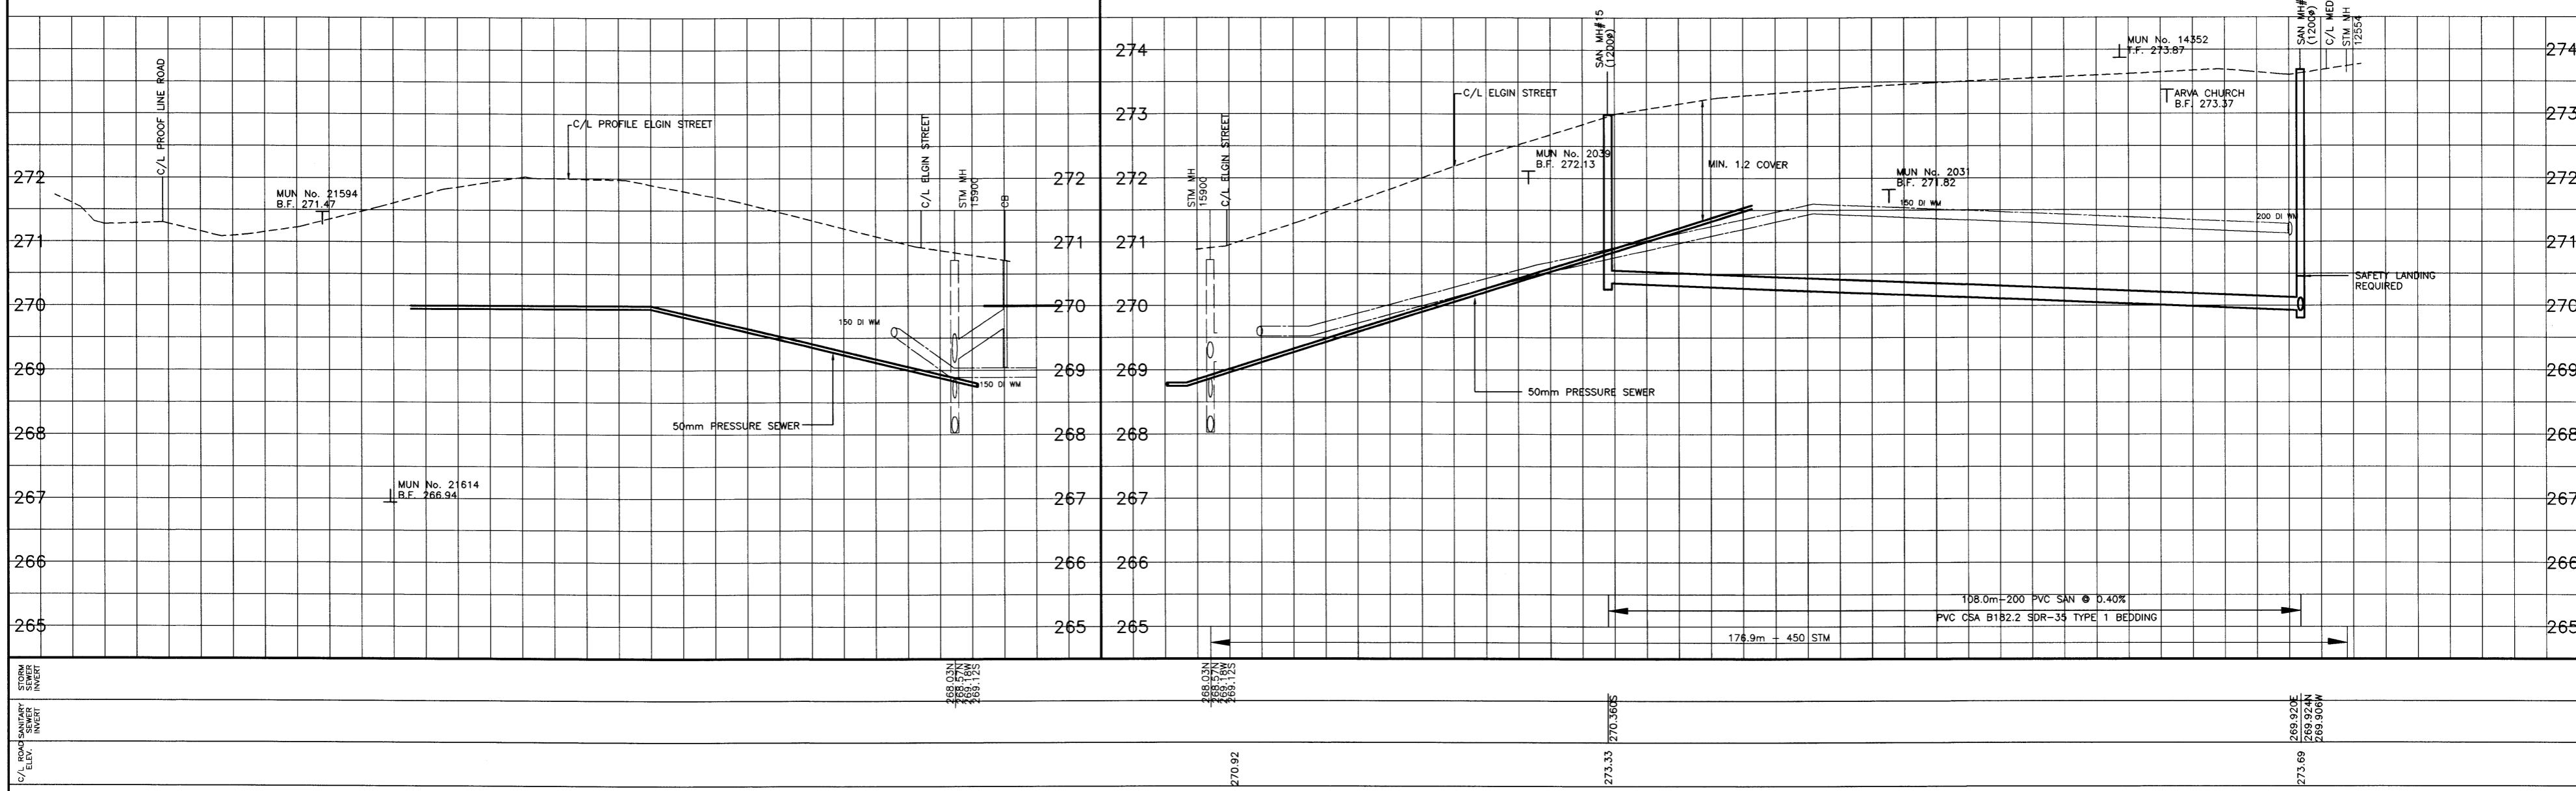
**DILLON**  
CONSULTING




TOWNSHIP  
OF  
MIDDLESEX  
CENTRE

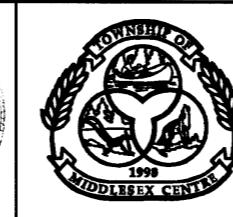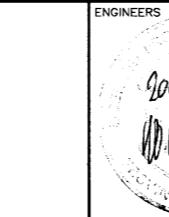ARVA SANITARY SEWAGE SYSTEM  
ELGIN STREET  
FROM ELGIN STREET TO MEDWAY ROAD


PROJECT NO  
00-7278  
SHEET NO  
9  
PLAN FILE NO

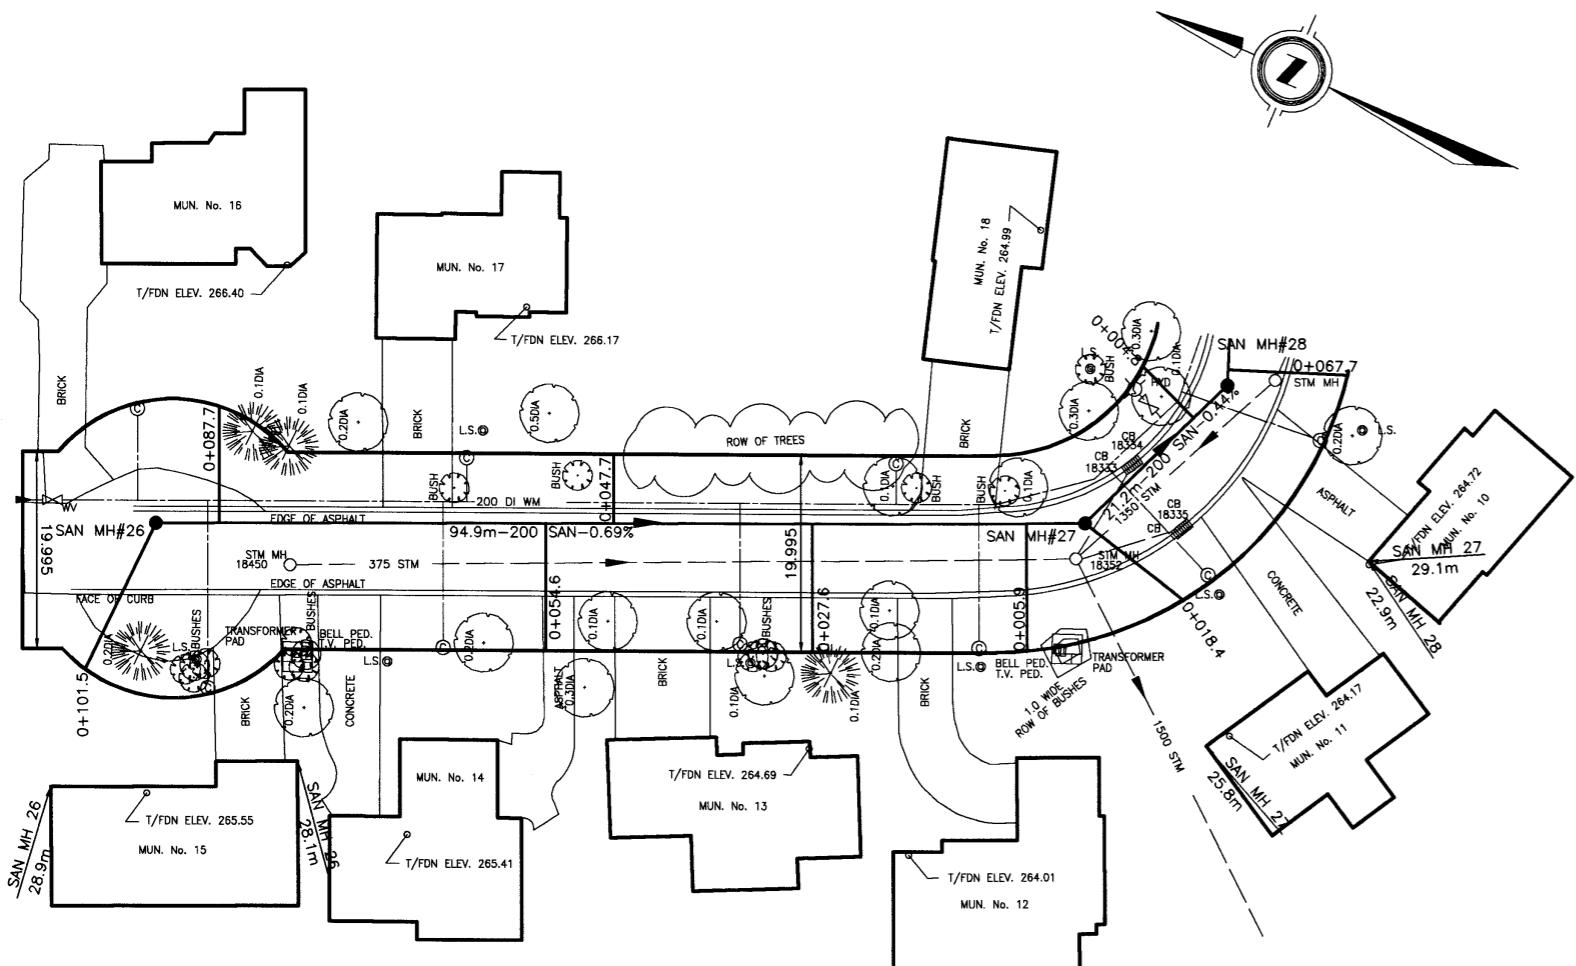


CROYDON DRIVE

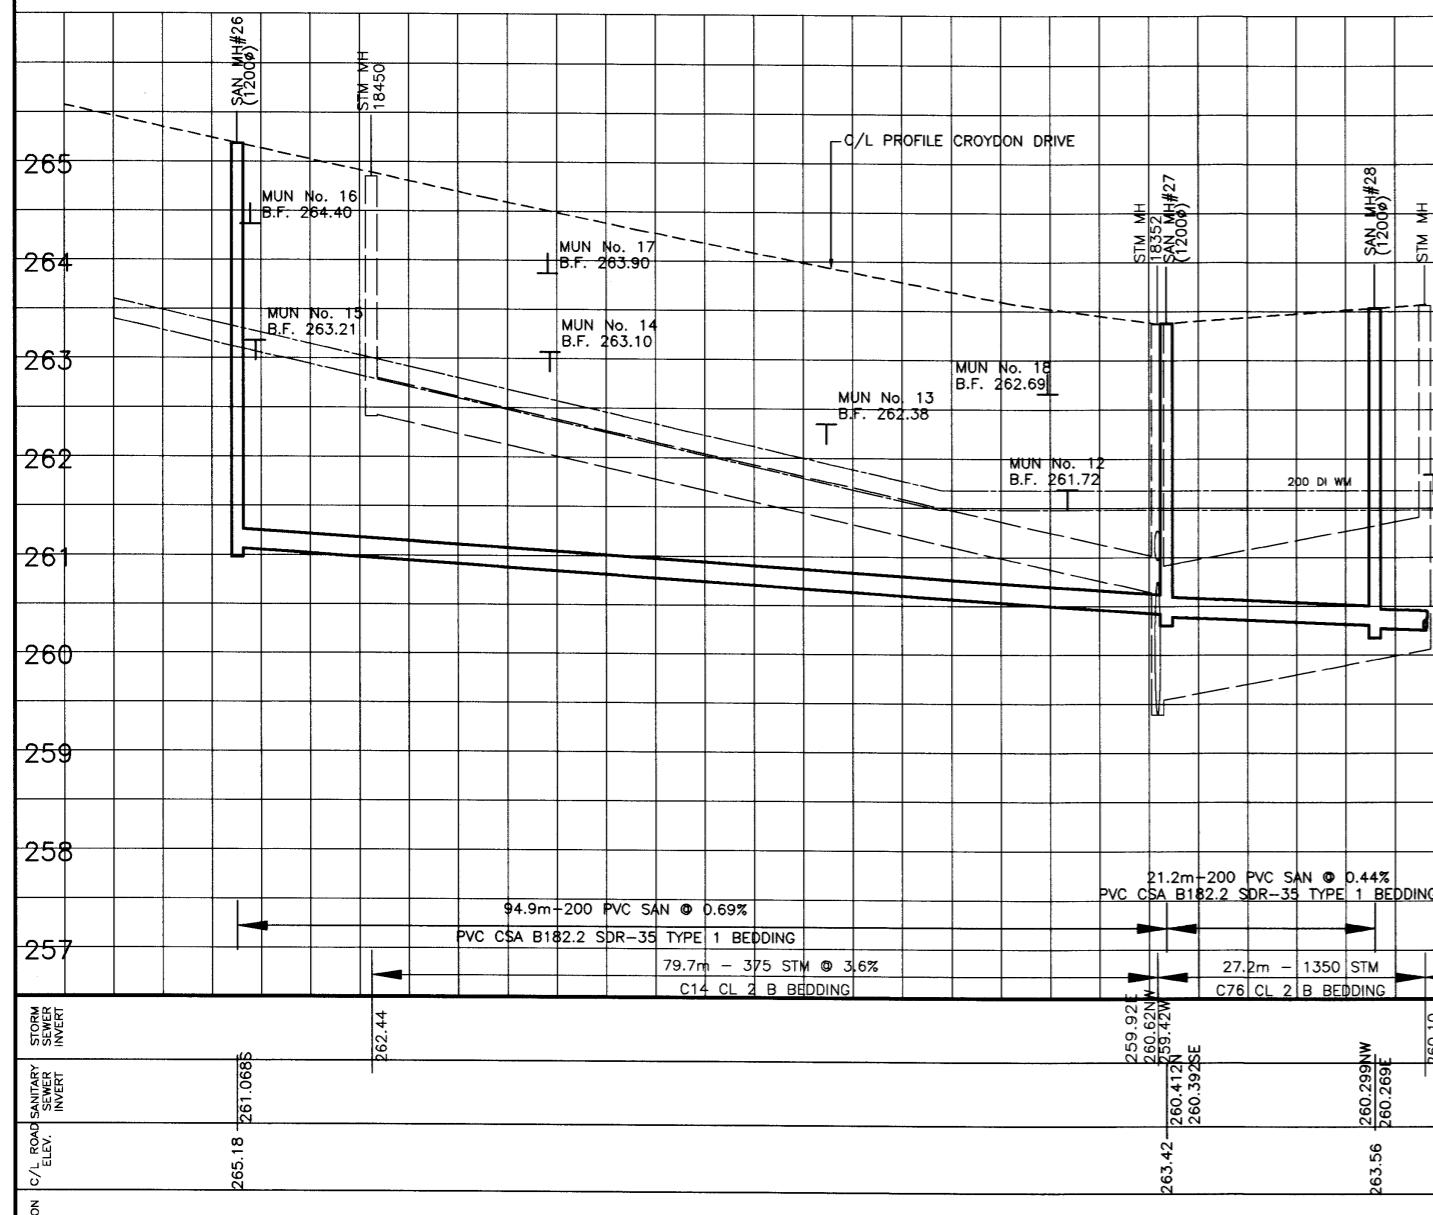



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CROYDON DRIVE

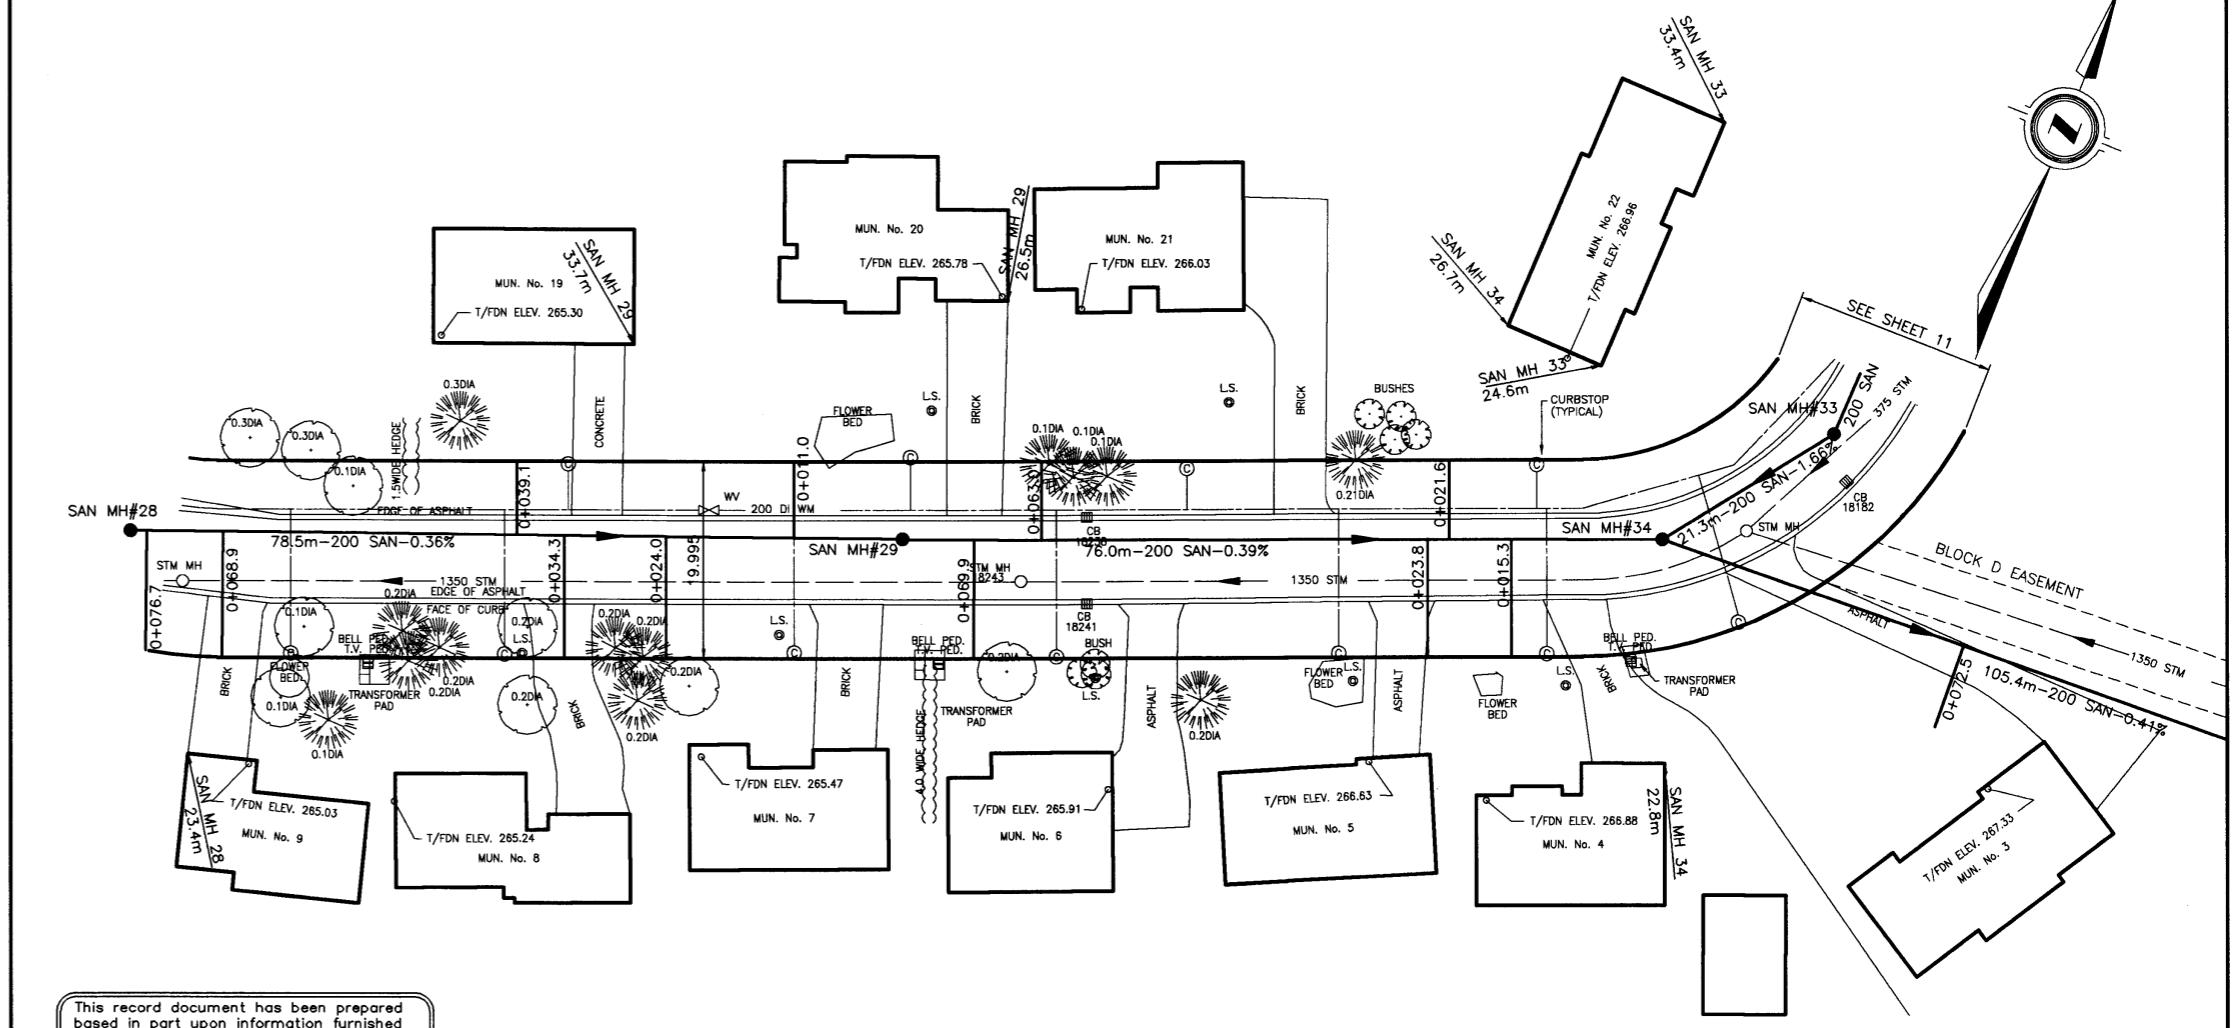


AS CONSTRUCTED NOTES	AS CONSTRUCTED SERVICES	COMPLETION
1		DES
2		DRA
3		CHE
4		APP
5		DAT

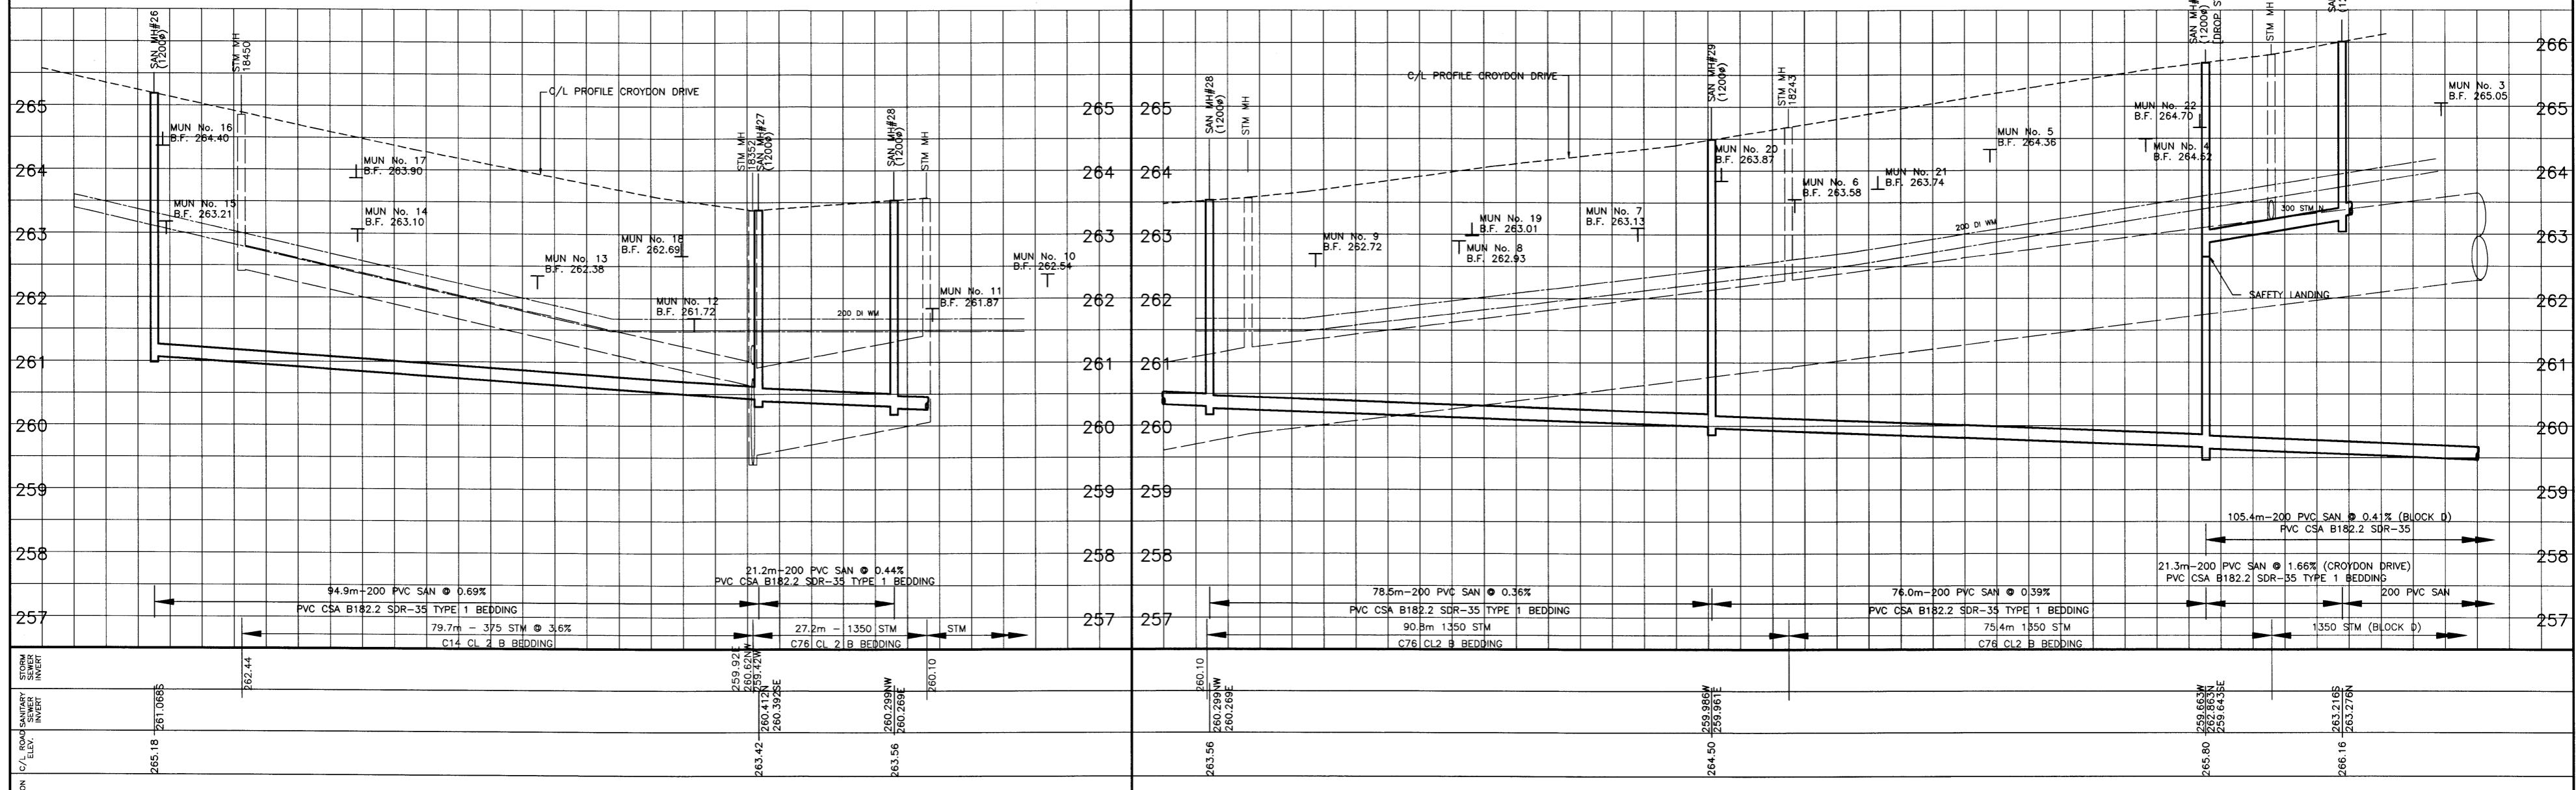


TOWNSHIP  
OF  
MIDDLESEX  
CENTRE
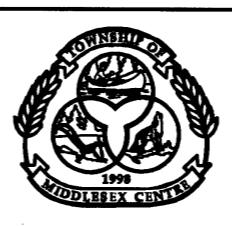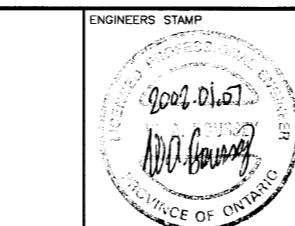
<p><i>TOWNSHIP OF MIDDLESEX CENTRE</i></p>	<p>SCALE</p>  <p>1:500      1:50</p> <p>5.0      0      10m</p> <p>0.5      0      1.0m</p> <p>HORIZONTAL</p> <p>VERTICAL</p>	<p>ARVA SANITARY SEWAGE SEWAGE</p> <p>CROYDEN DRIVE</p> <p>FROM 435m WEST OF RICHMOND ST TO</p> <p>120m WEST OF RICHMOND STREET</p>
--	--	---

ARVA SANITARY SEWAGE SEWAGE	PROJECT No 00-7278
CROYDEN DRIVE FROM 435m WEST OF RICHMOND ST TO 120m WEST OF RICHMOND STREET	SHEET No 10
	PLAN FILE NO


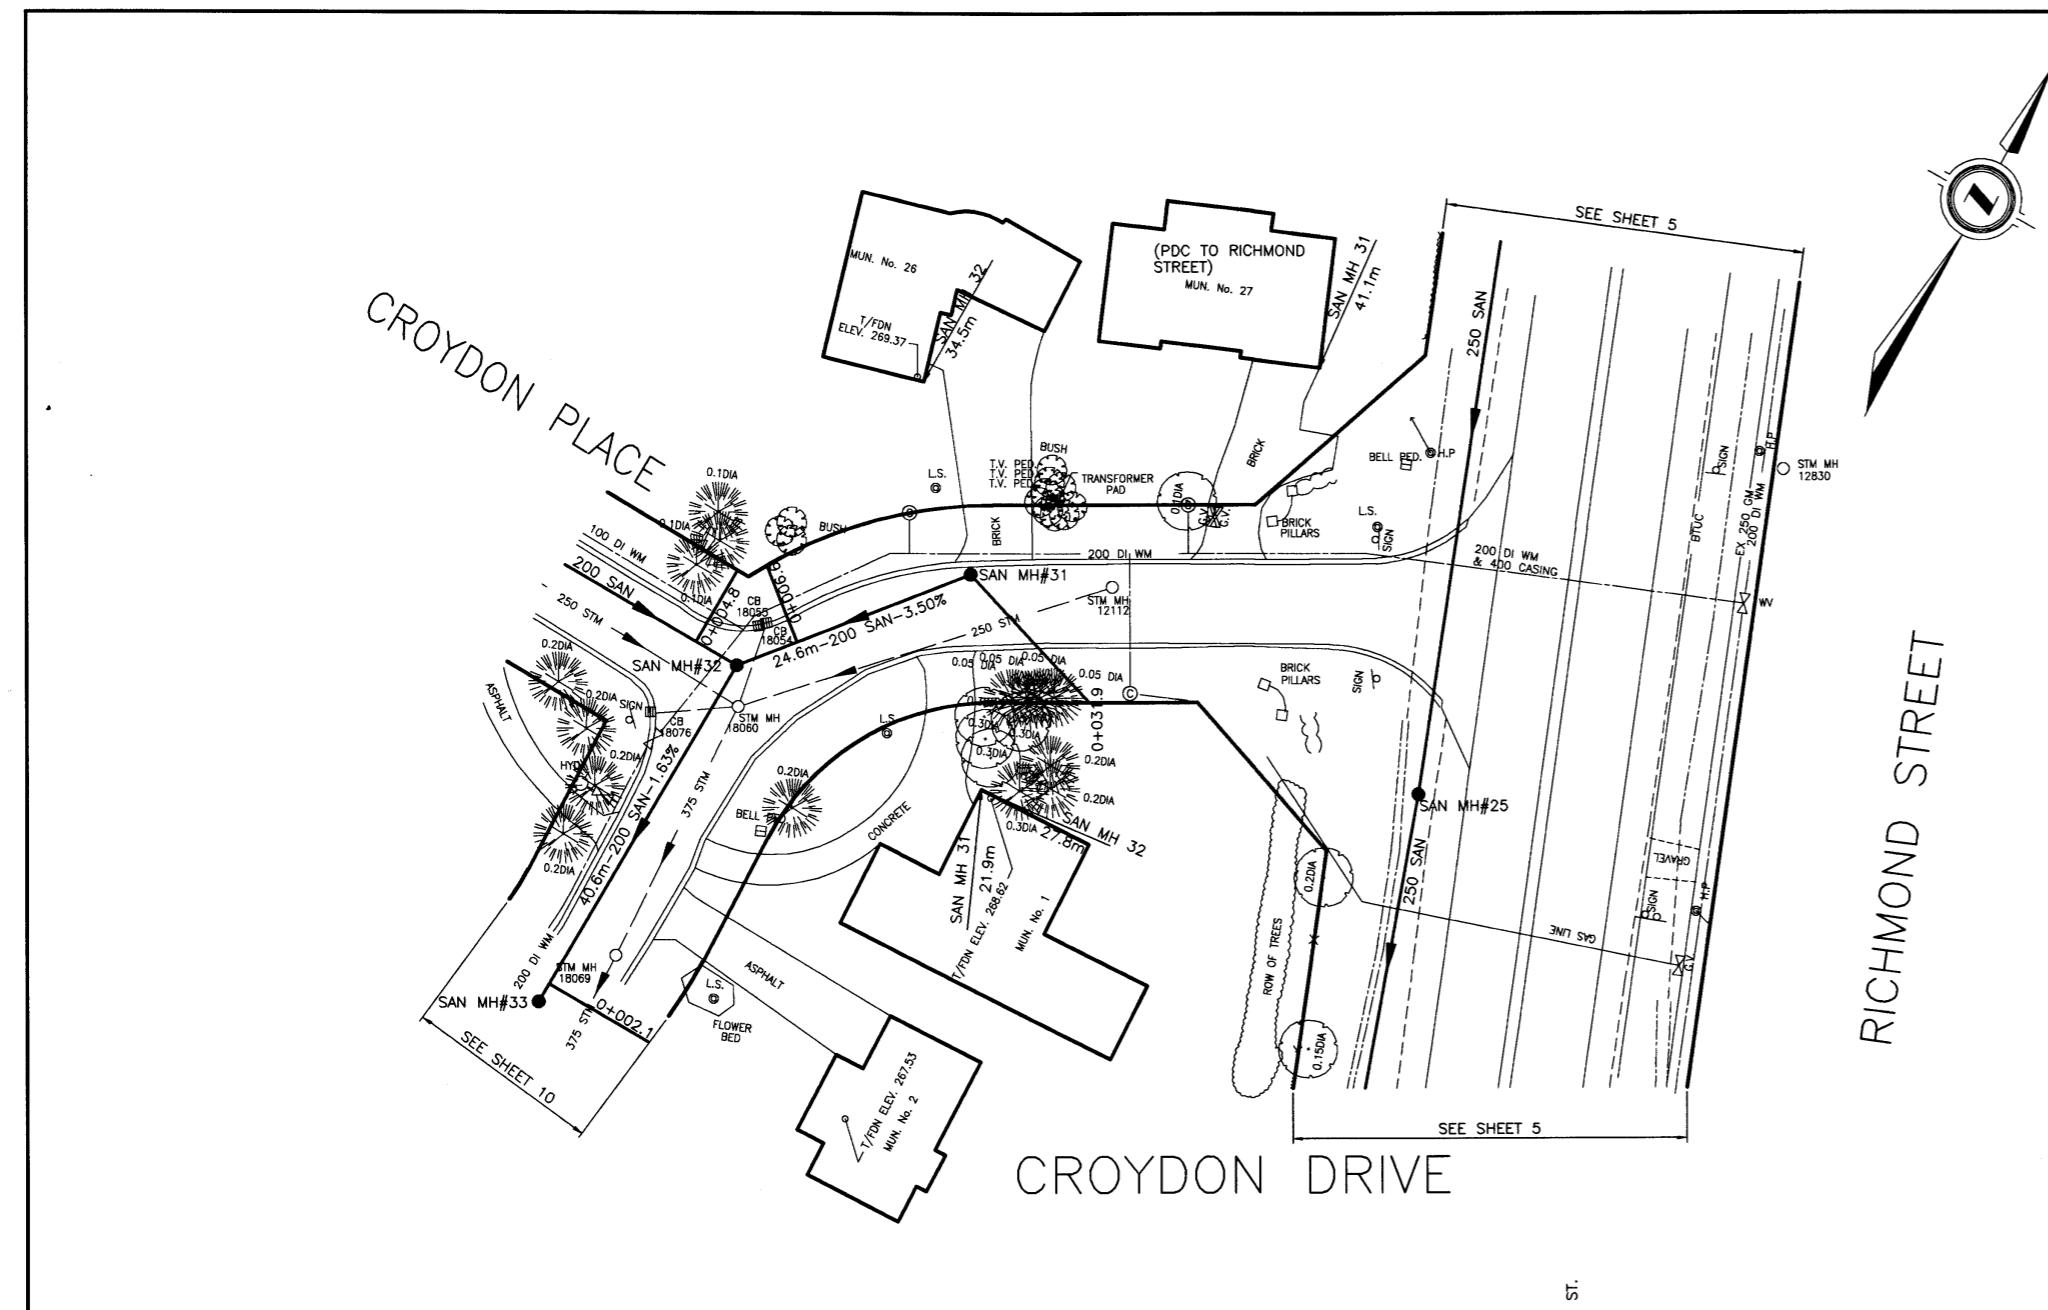


RICHMOND STREETS

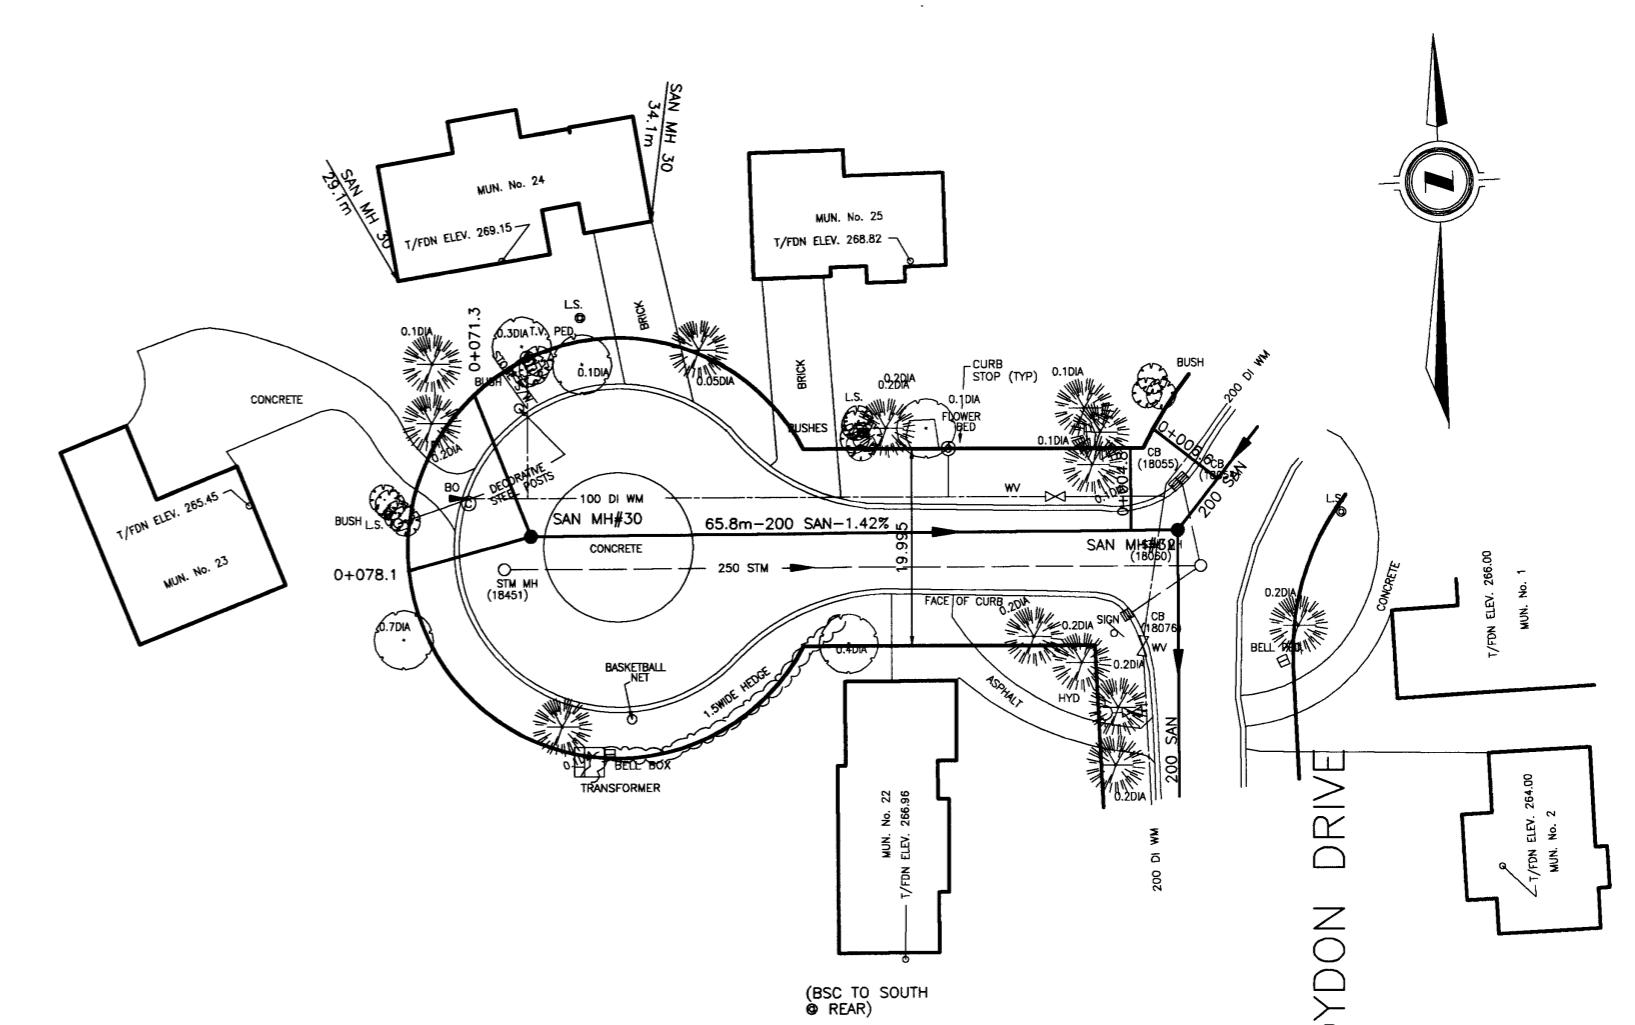



CROYDON PLACE

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AS CONSTRUCTED NOTES	AS CONSTRUCTED SERVICES	COMPLETION	
1			DESIGN RJP
2			DRAWN EM
3			CHECKED WA
4			APPROVED
5			DATE APR

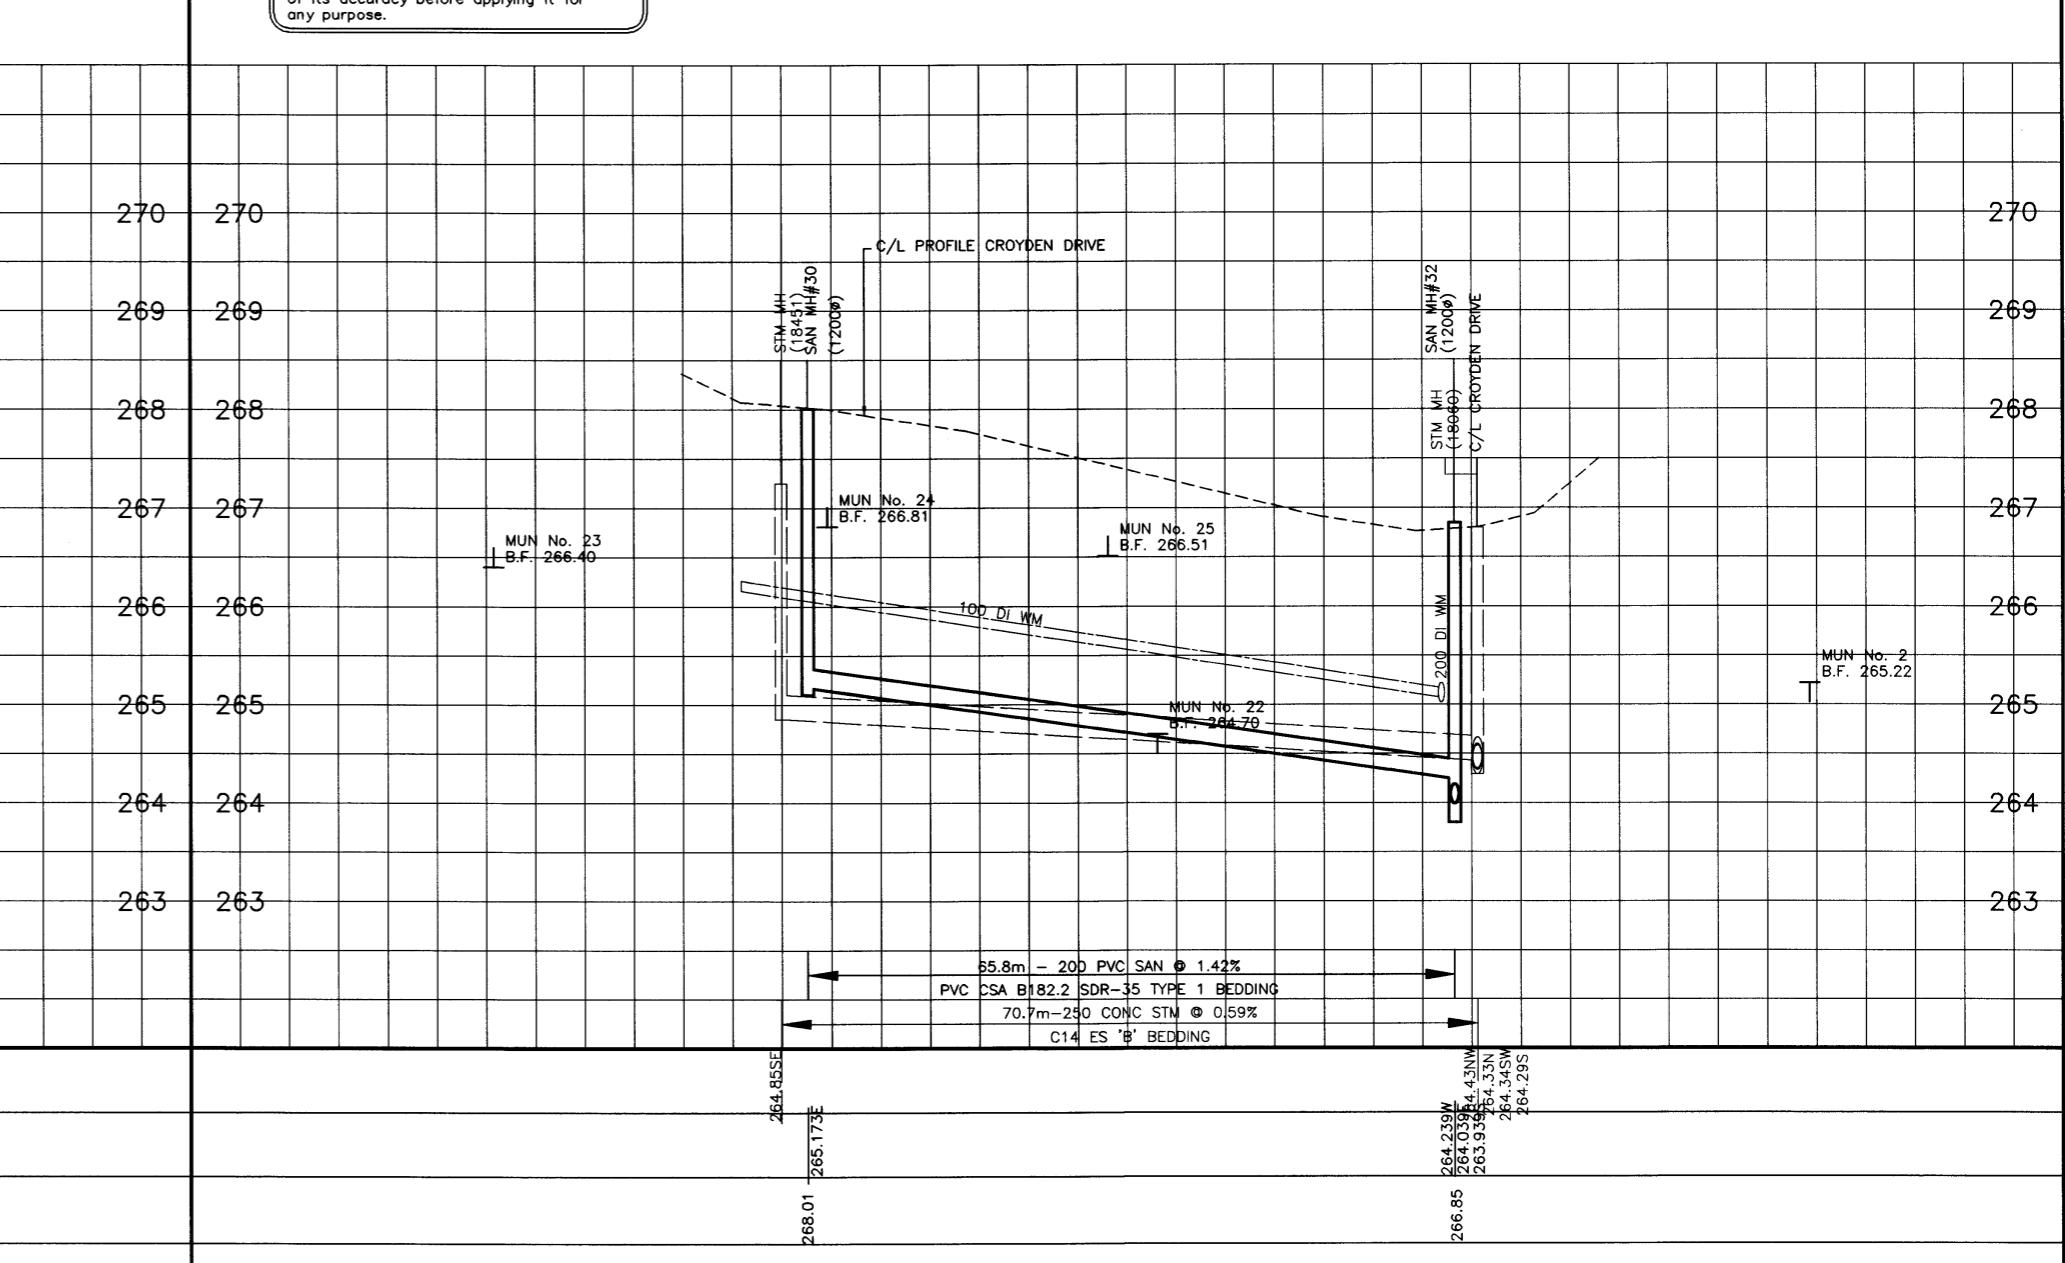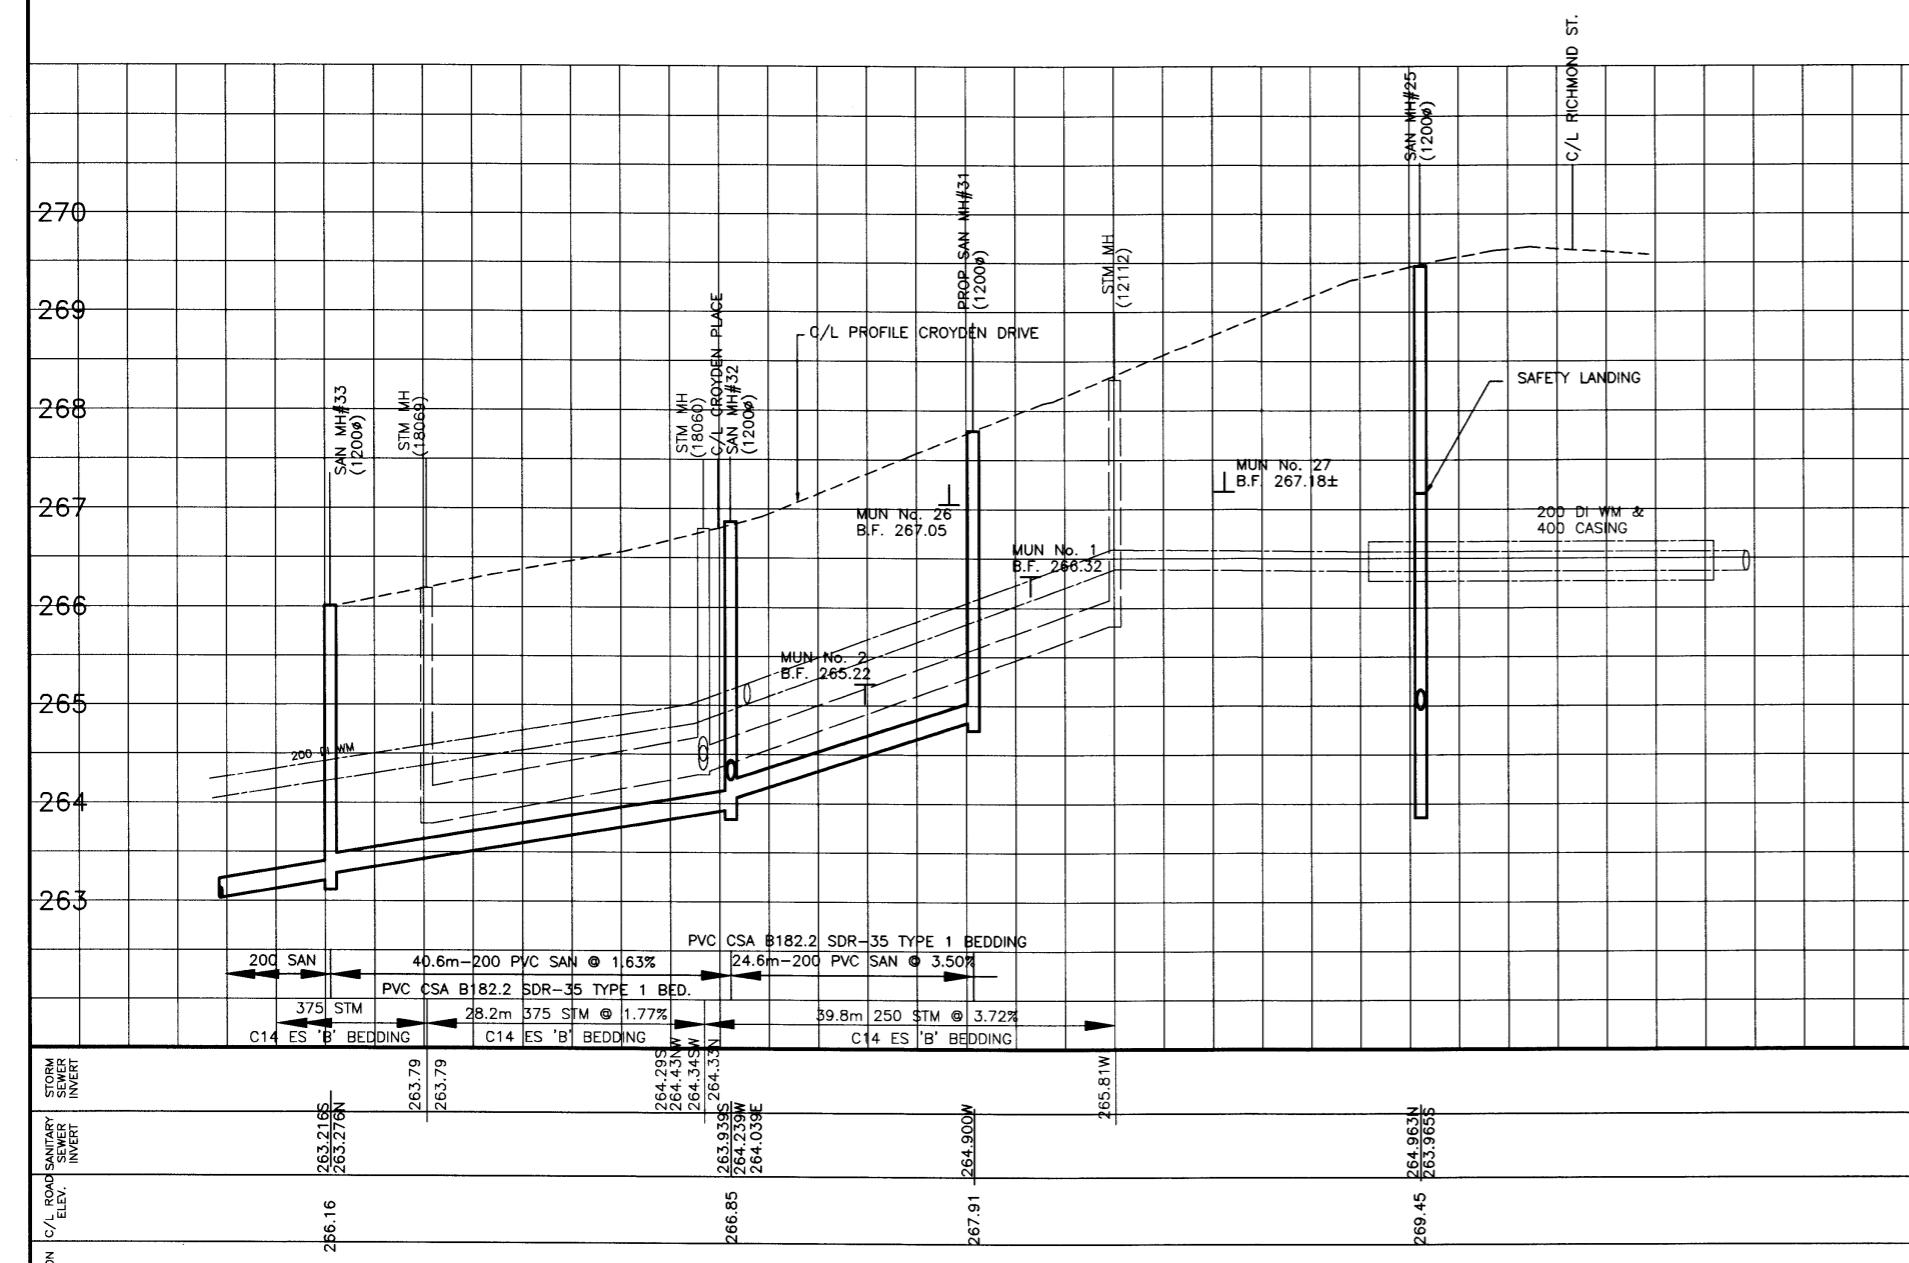The logo for Dillon Consulting features a stylized, wavy black line that forms the top curve of the letter 'D'. Below this, the word 'DILLON' is written in a bold, sans-serif font, with 'CONSULTING' in a smaller font size directly beneath it.



*TOWNSHIP  
OF  
MIDDLESEX  
CENTRE*

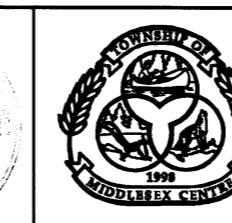
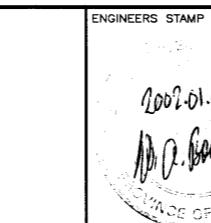
ARVA SANITARY SEWAGE SYSTEM

CROYDON DRIVE  
120m W. OF RICHMOND ST TO RICHMOND ST  
CROYDON PLACE

PROJECT No


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PLAN FILE No

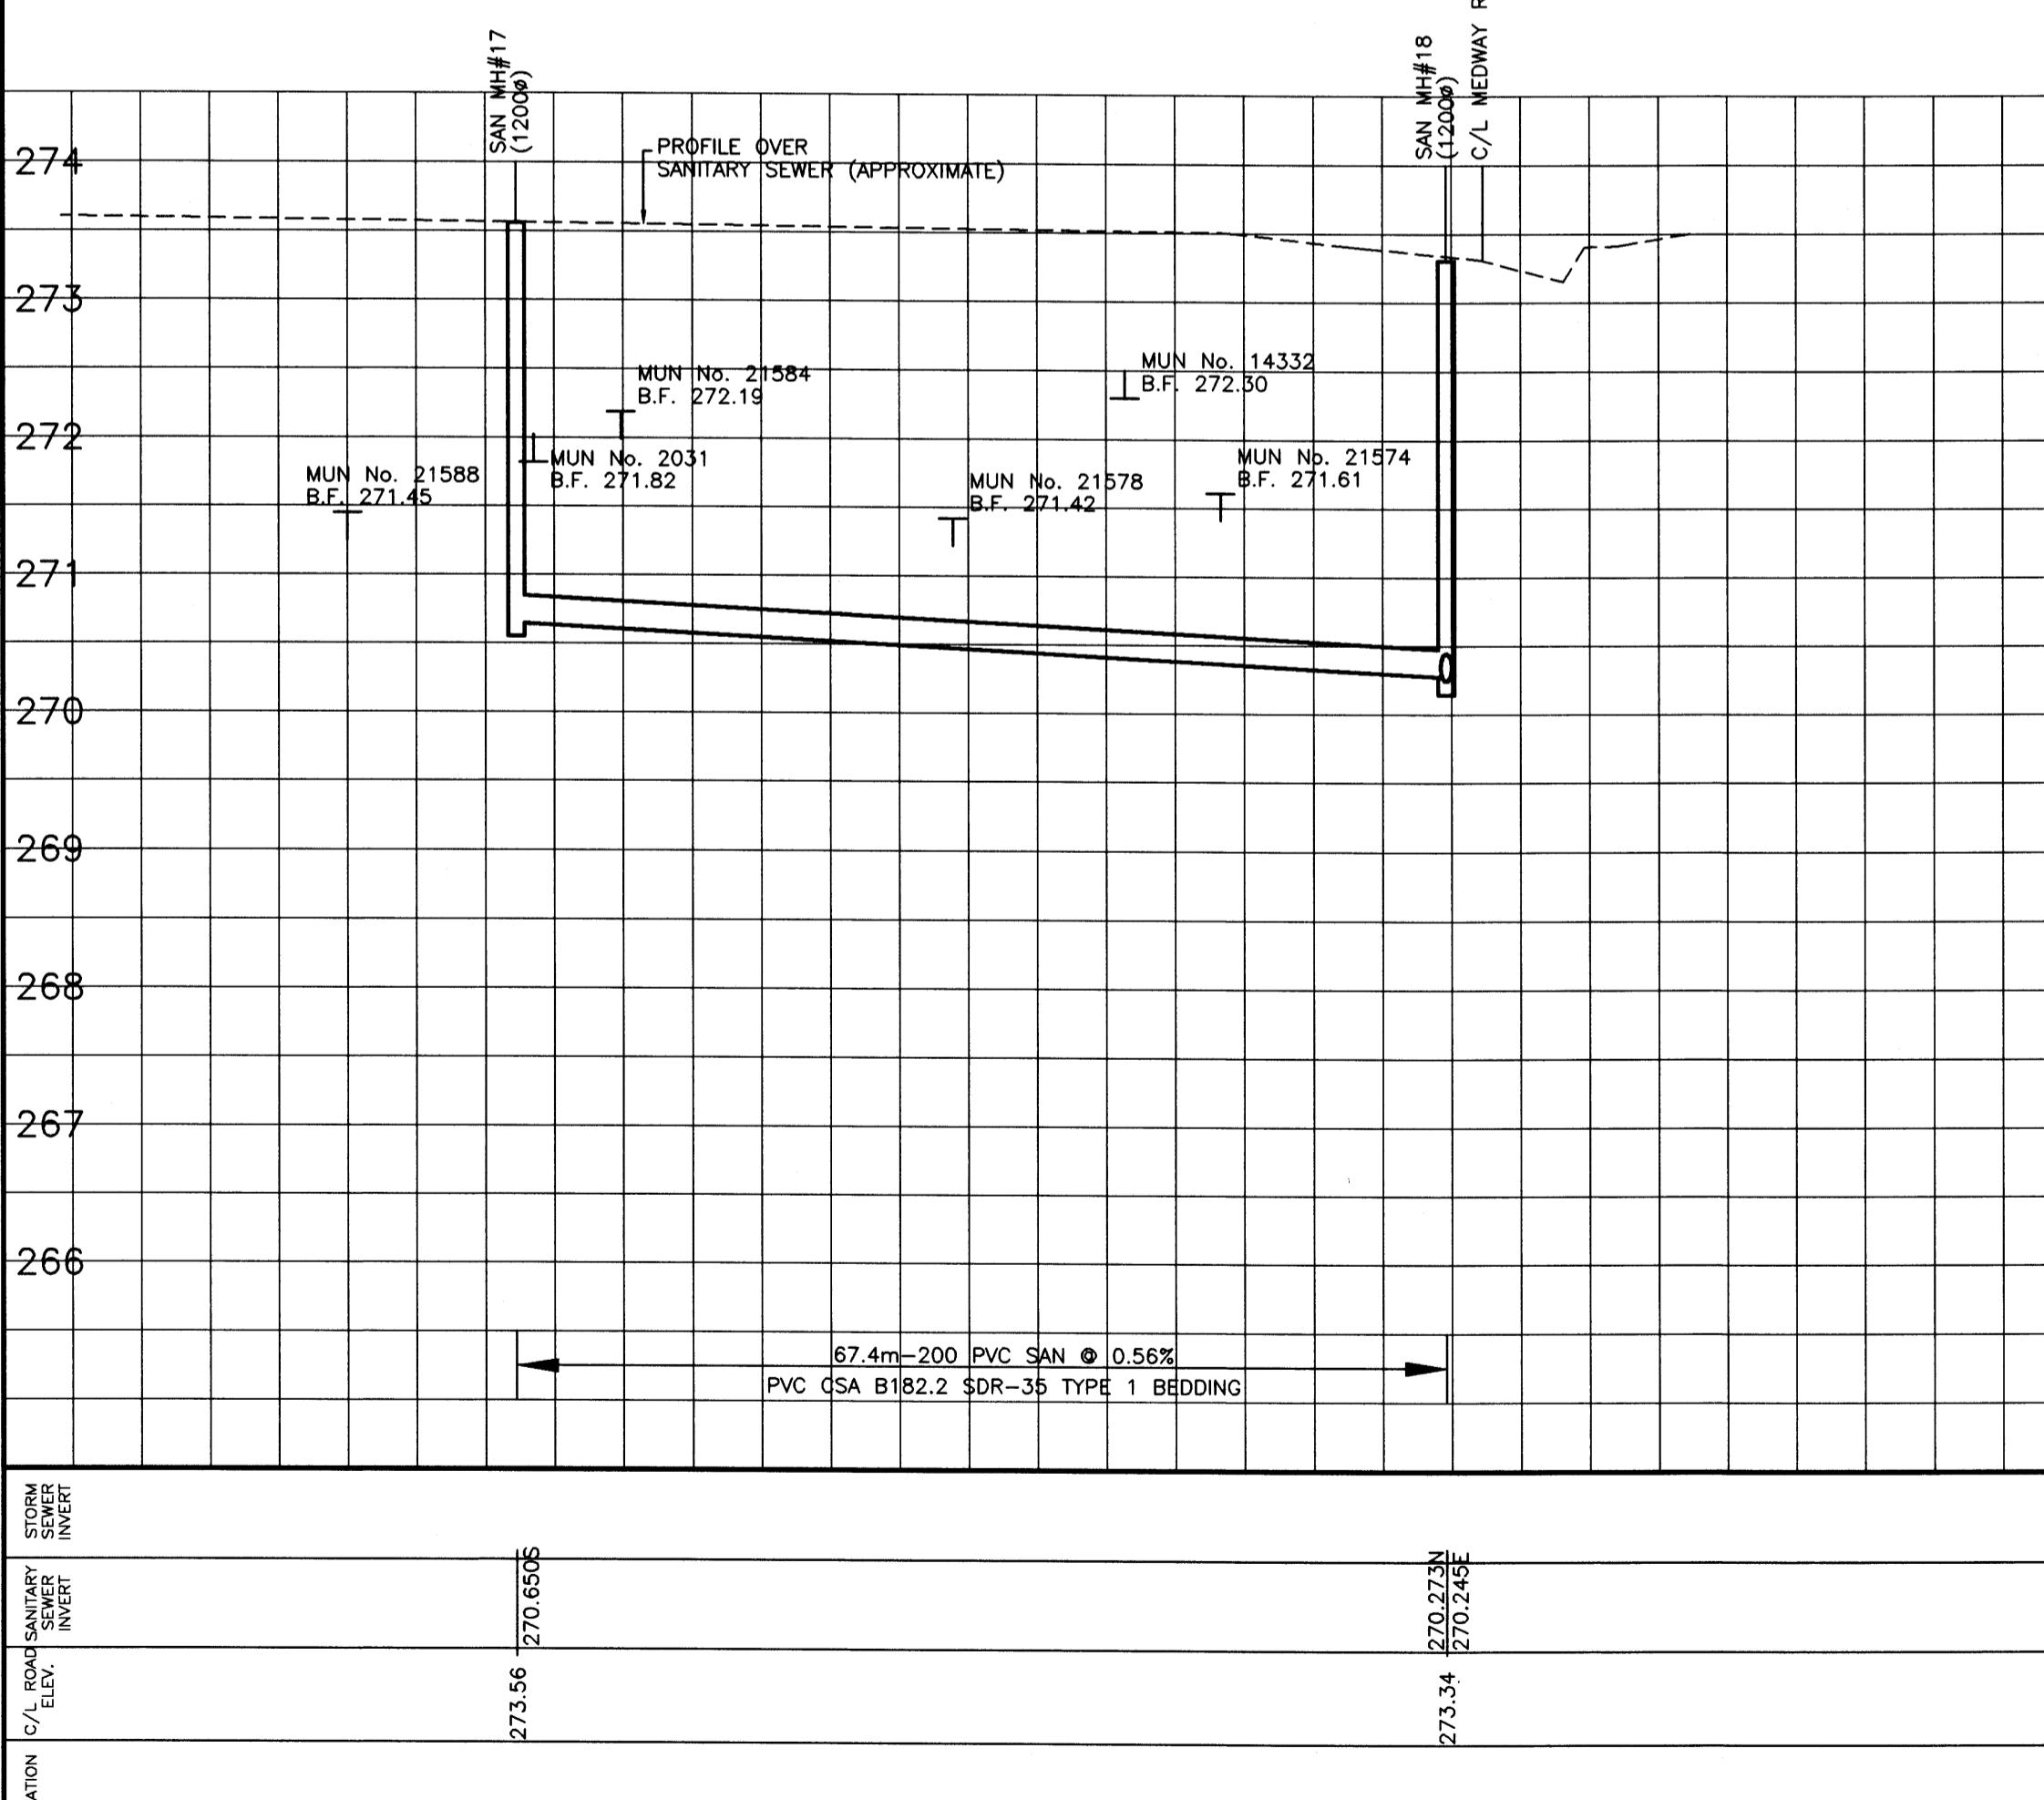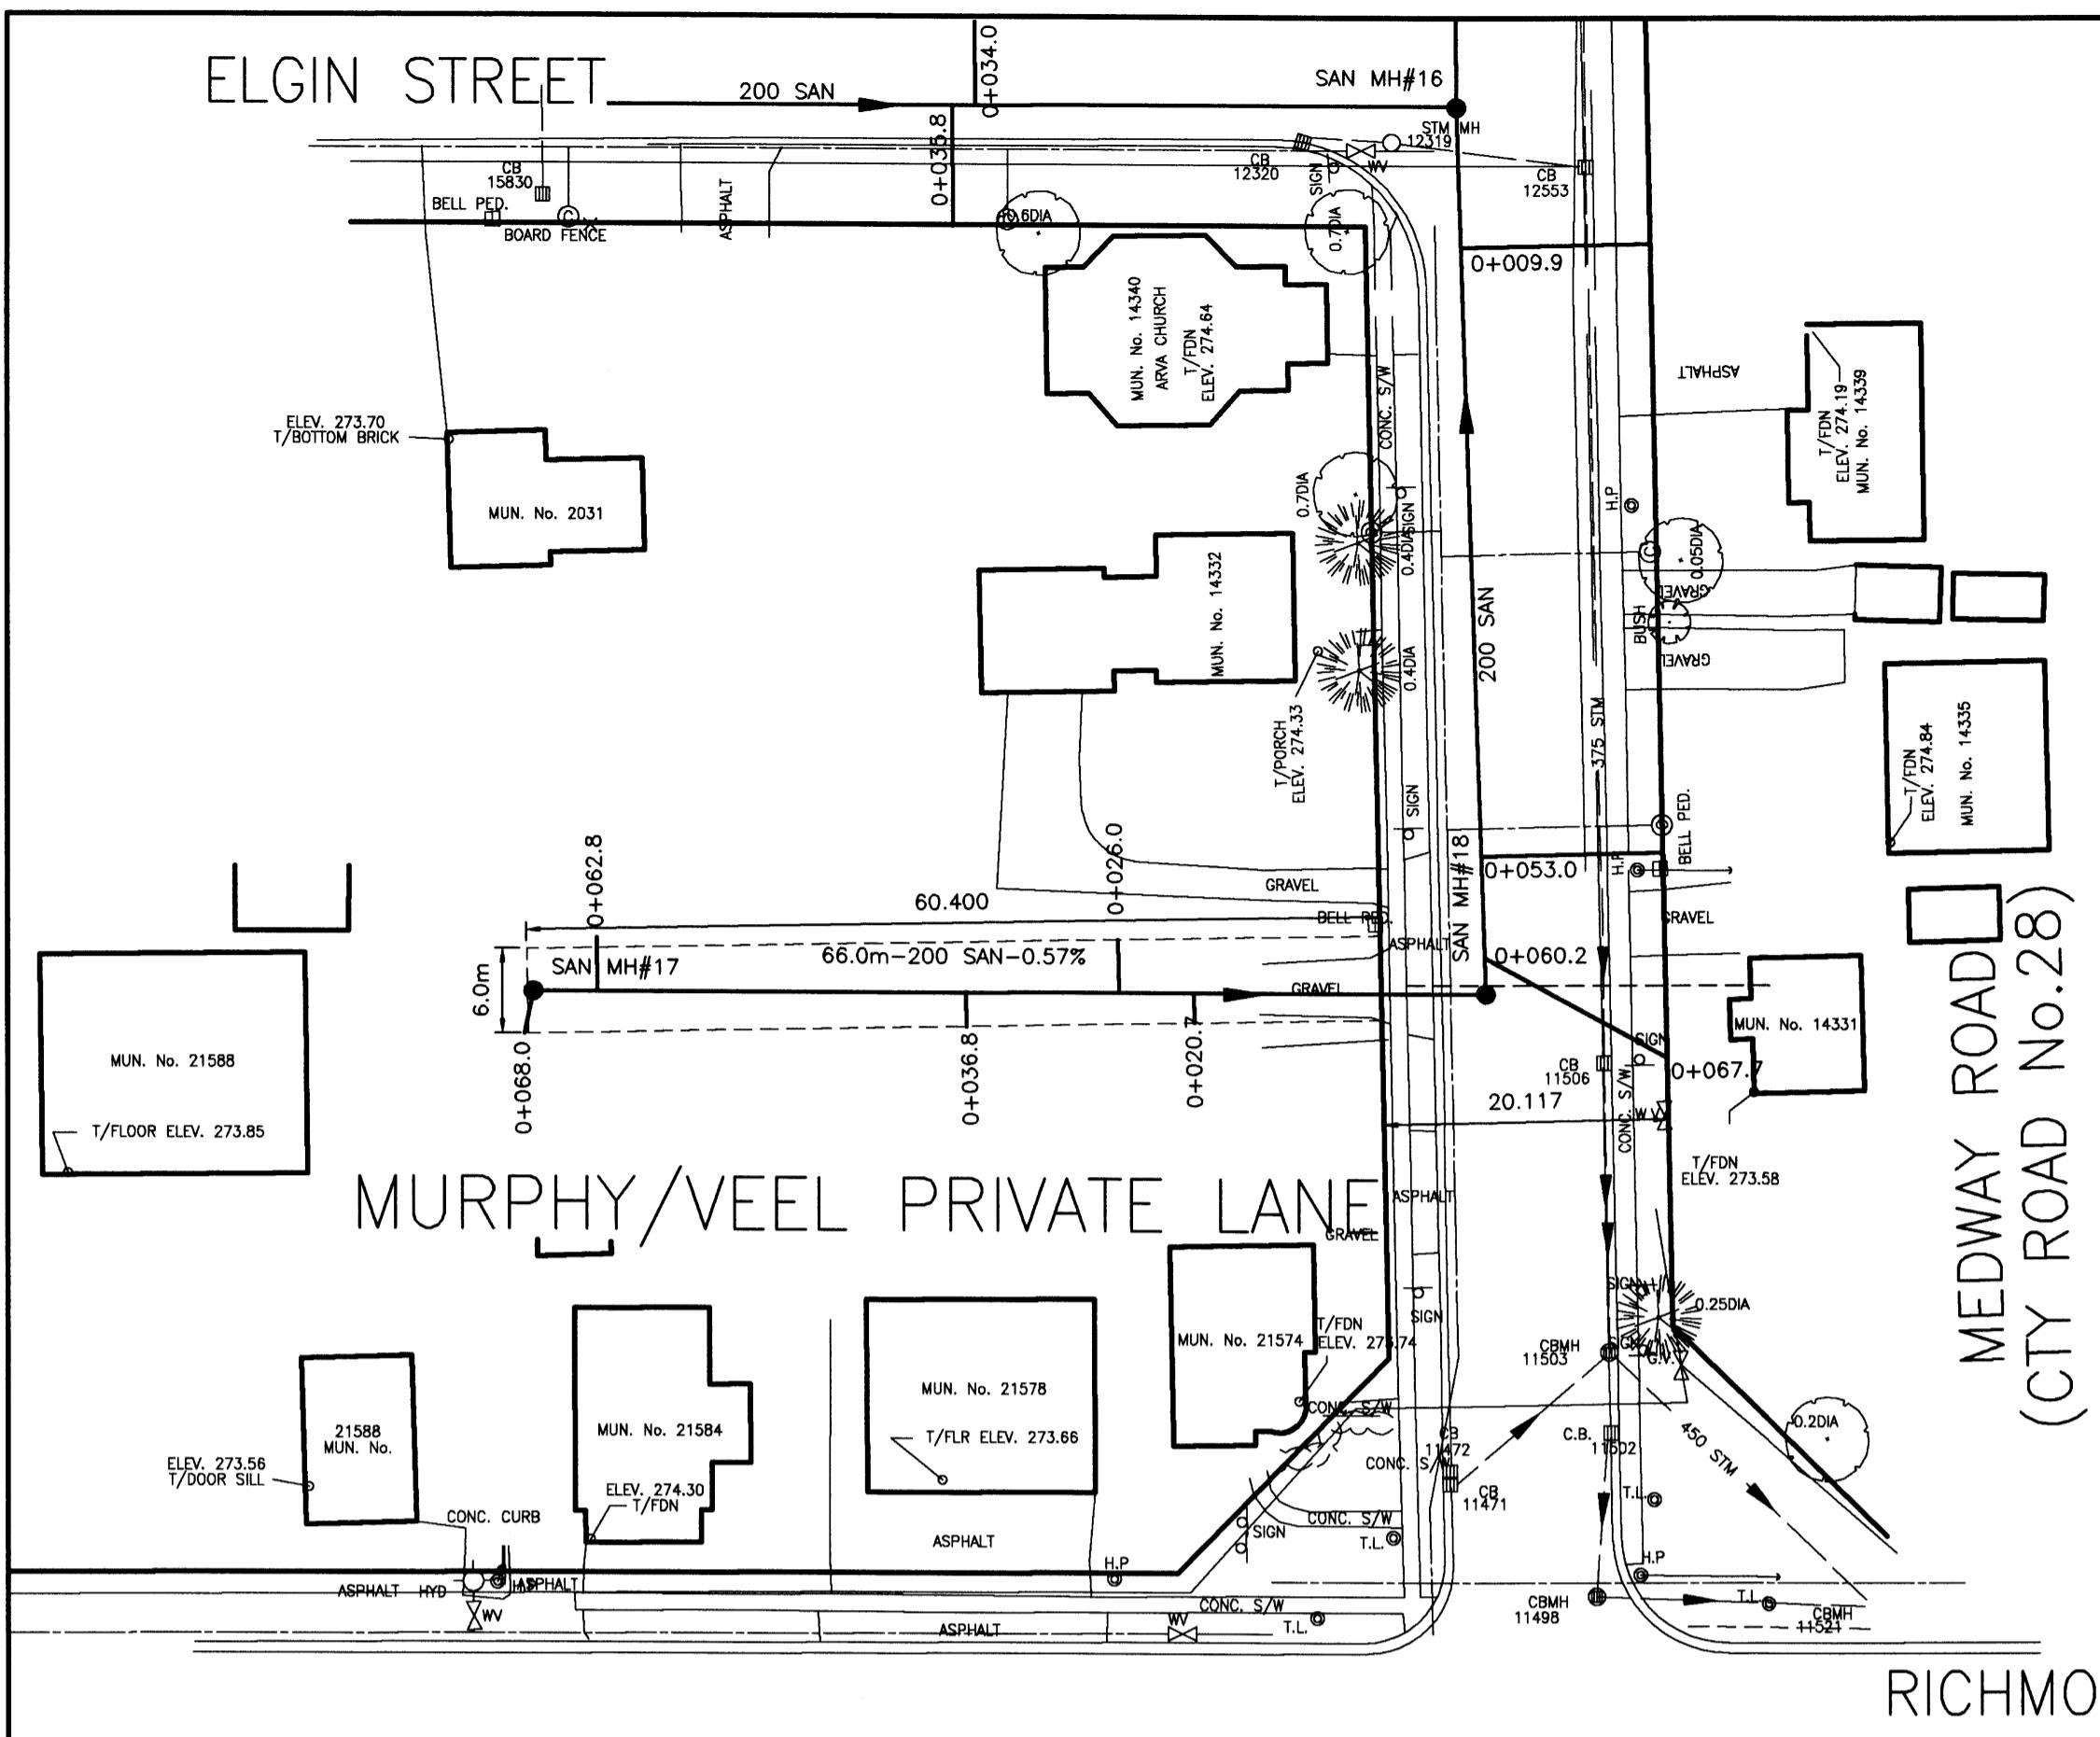

AS CONSTRUCTED NOTES	AS CONSTRUCTED SERVICES	COMPLETION	DESIGN RJM	No.	REVISIONS	DATE	BY
1				1	AS CONSTRUCTED	NOV/01	WAB
2			DRAWN EMB				
3			CHECKED WAB				
4			APPROVED				
5			DATE APR 20/00				

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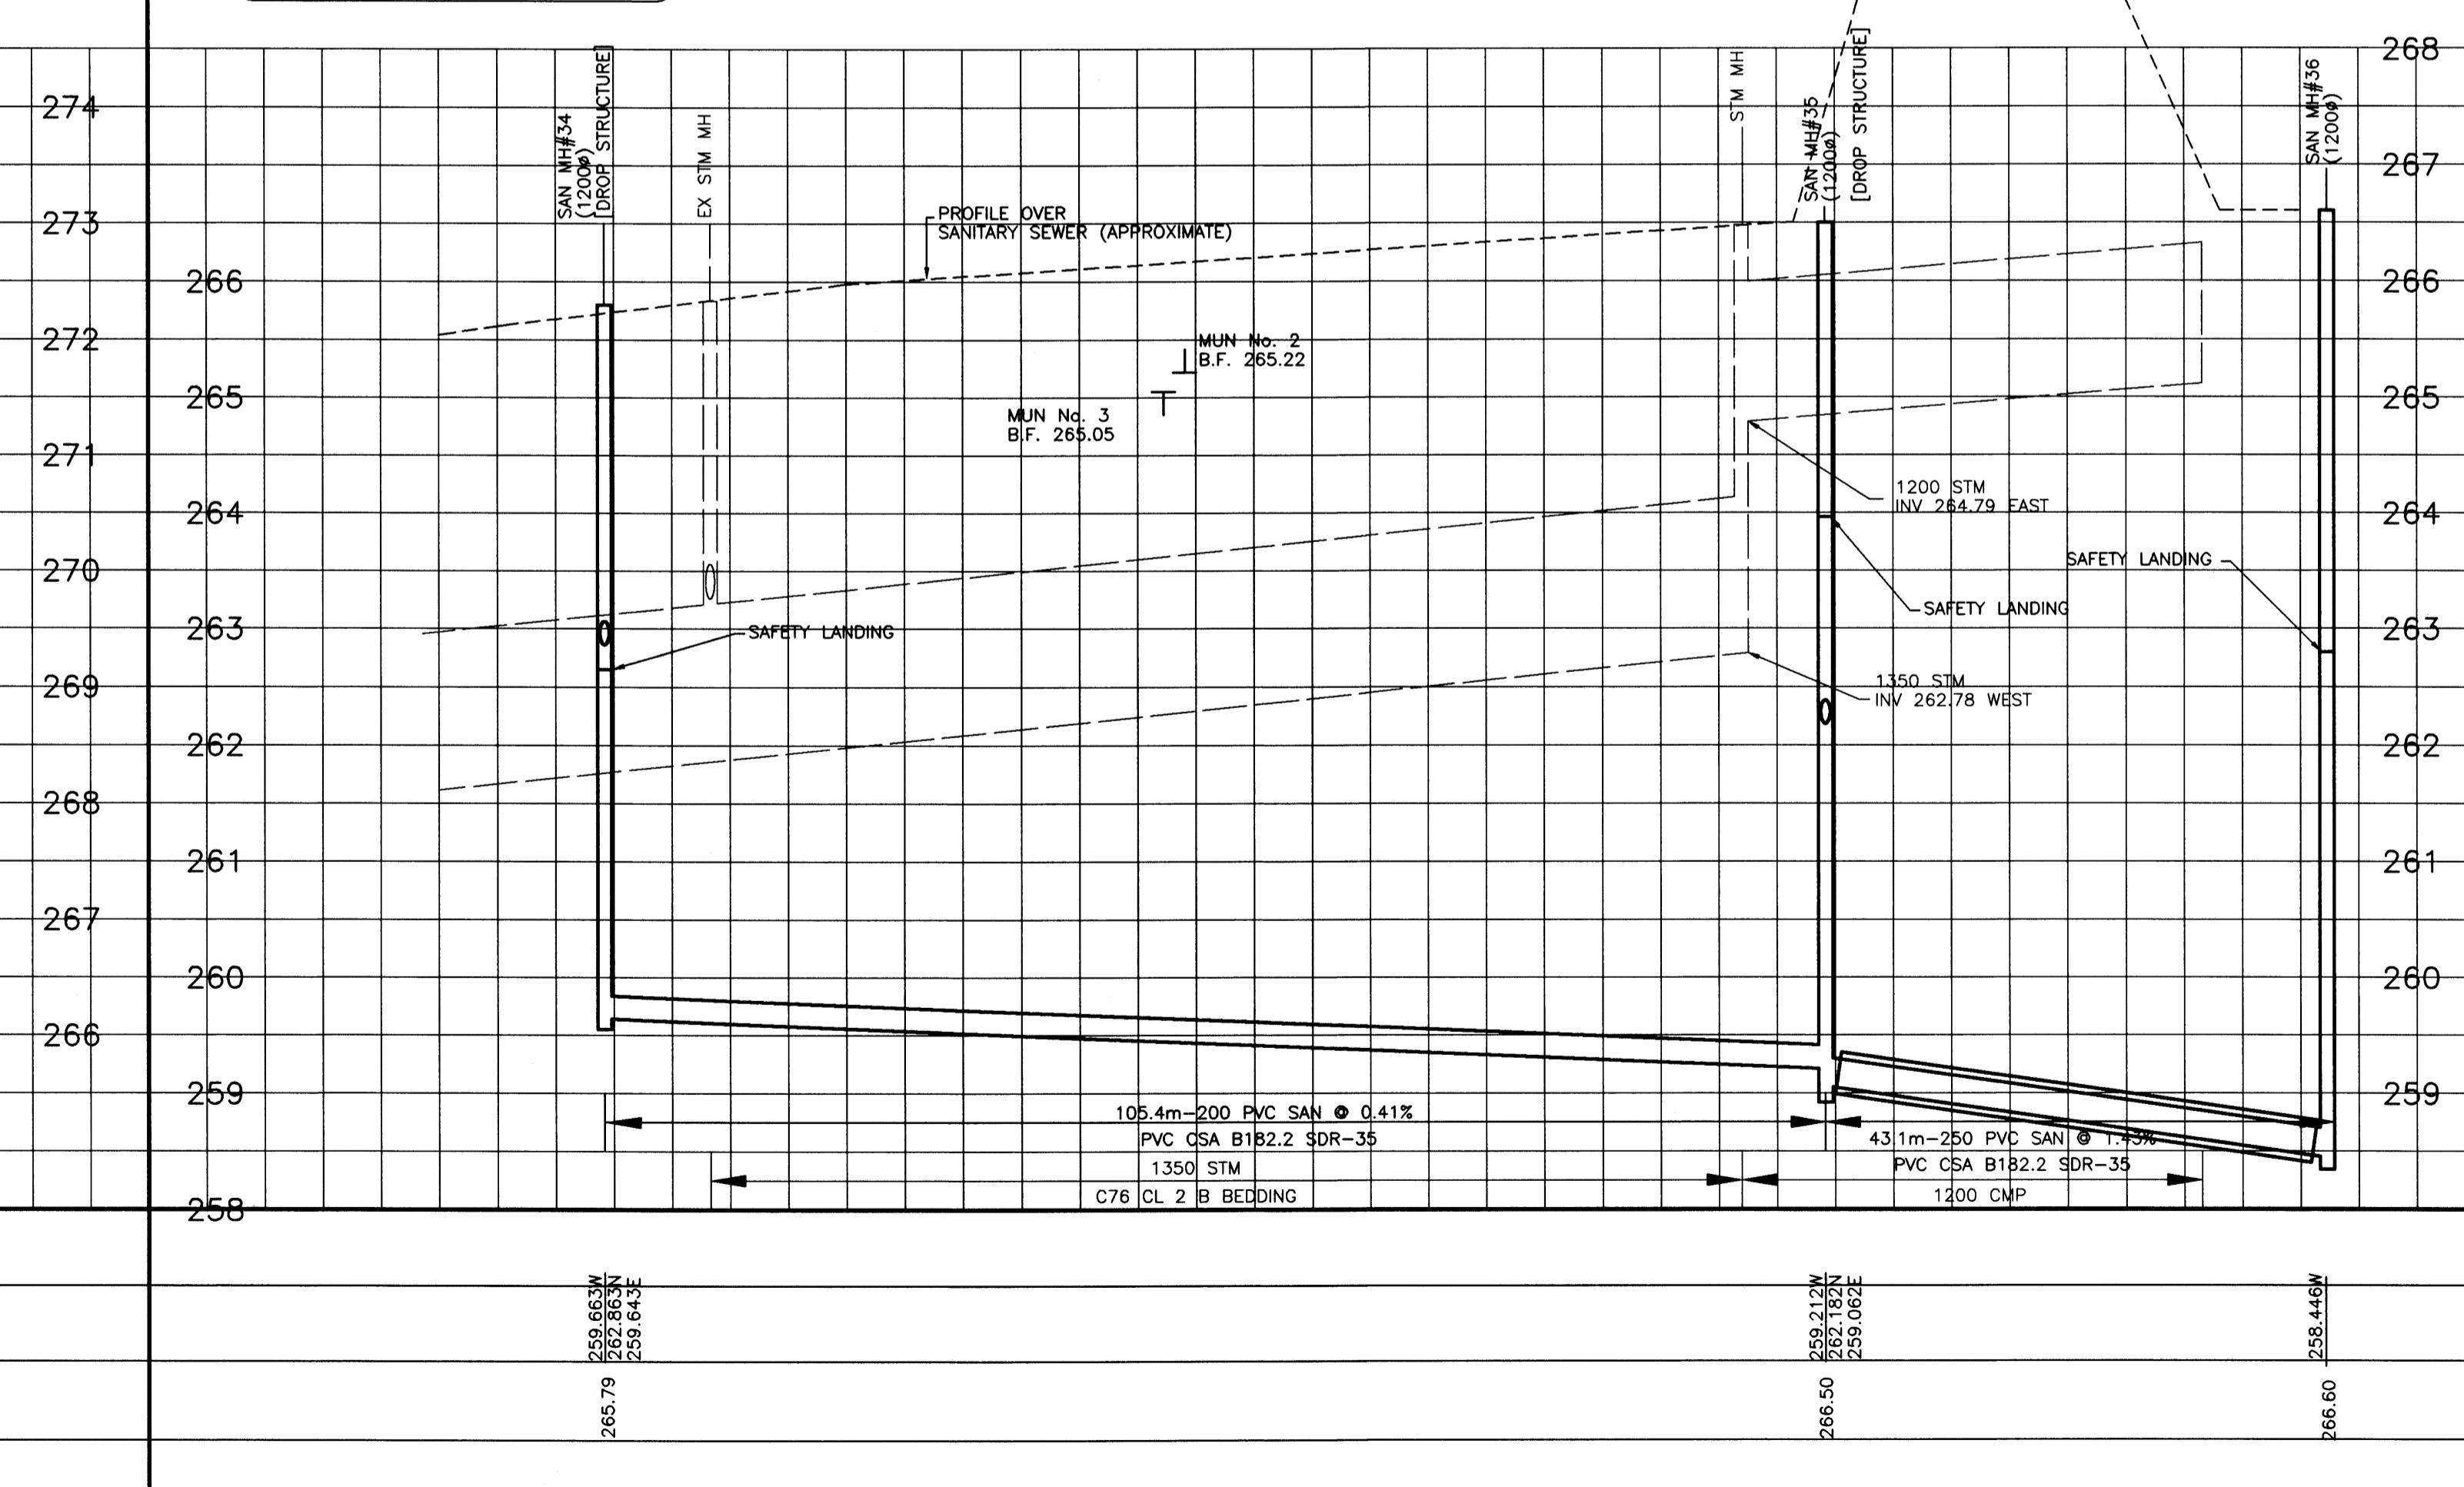
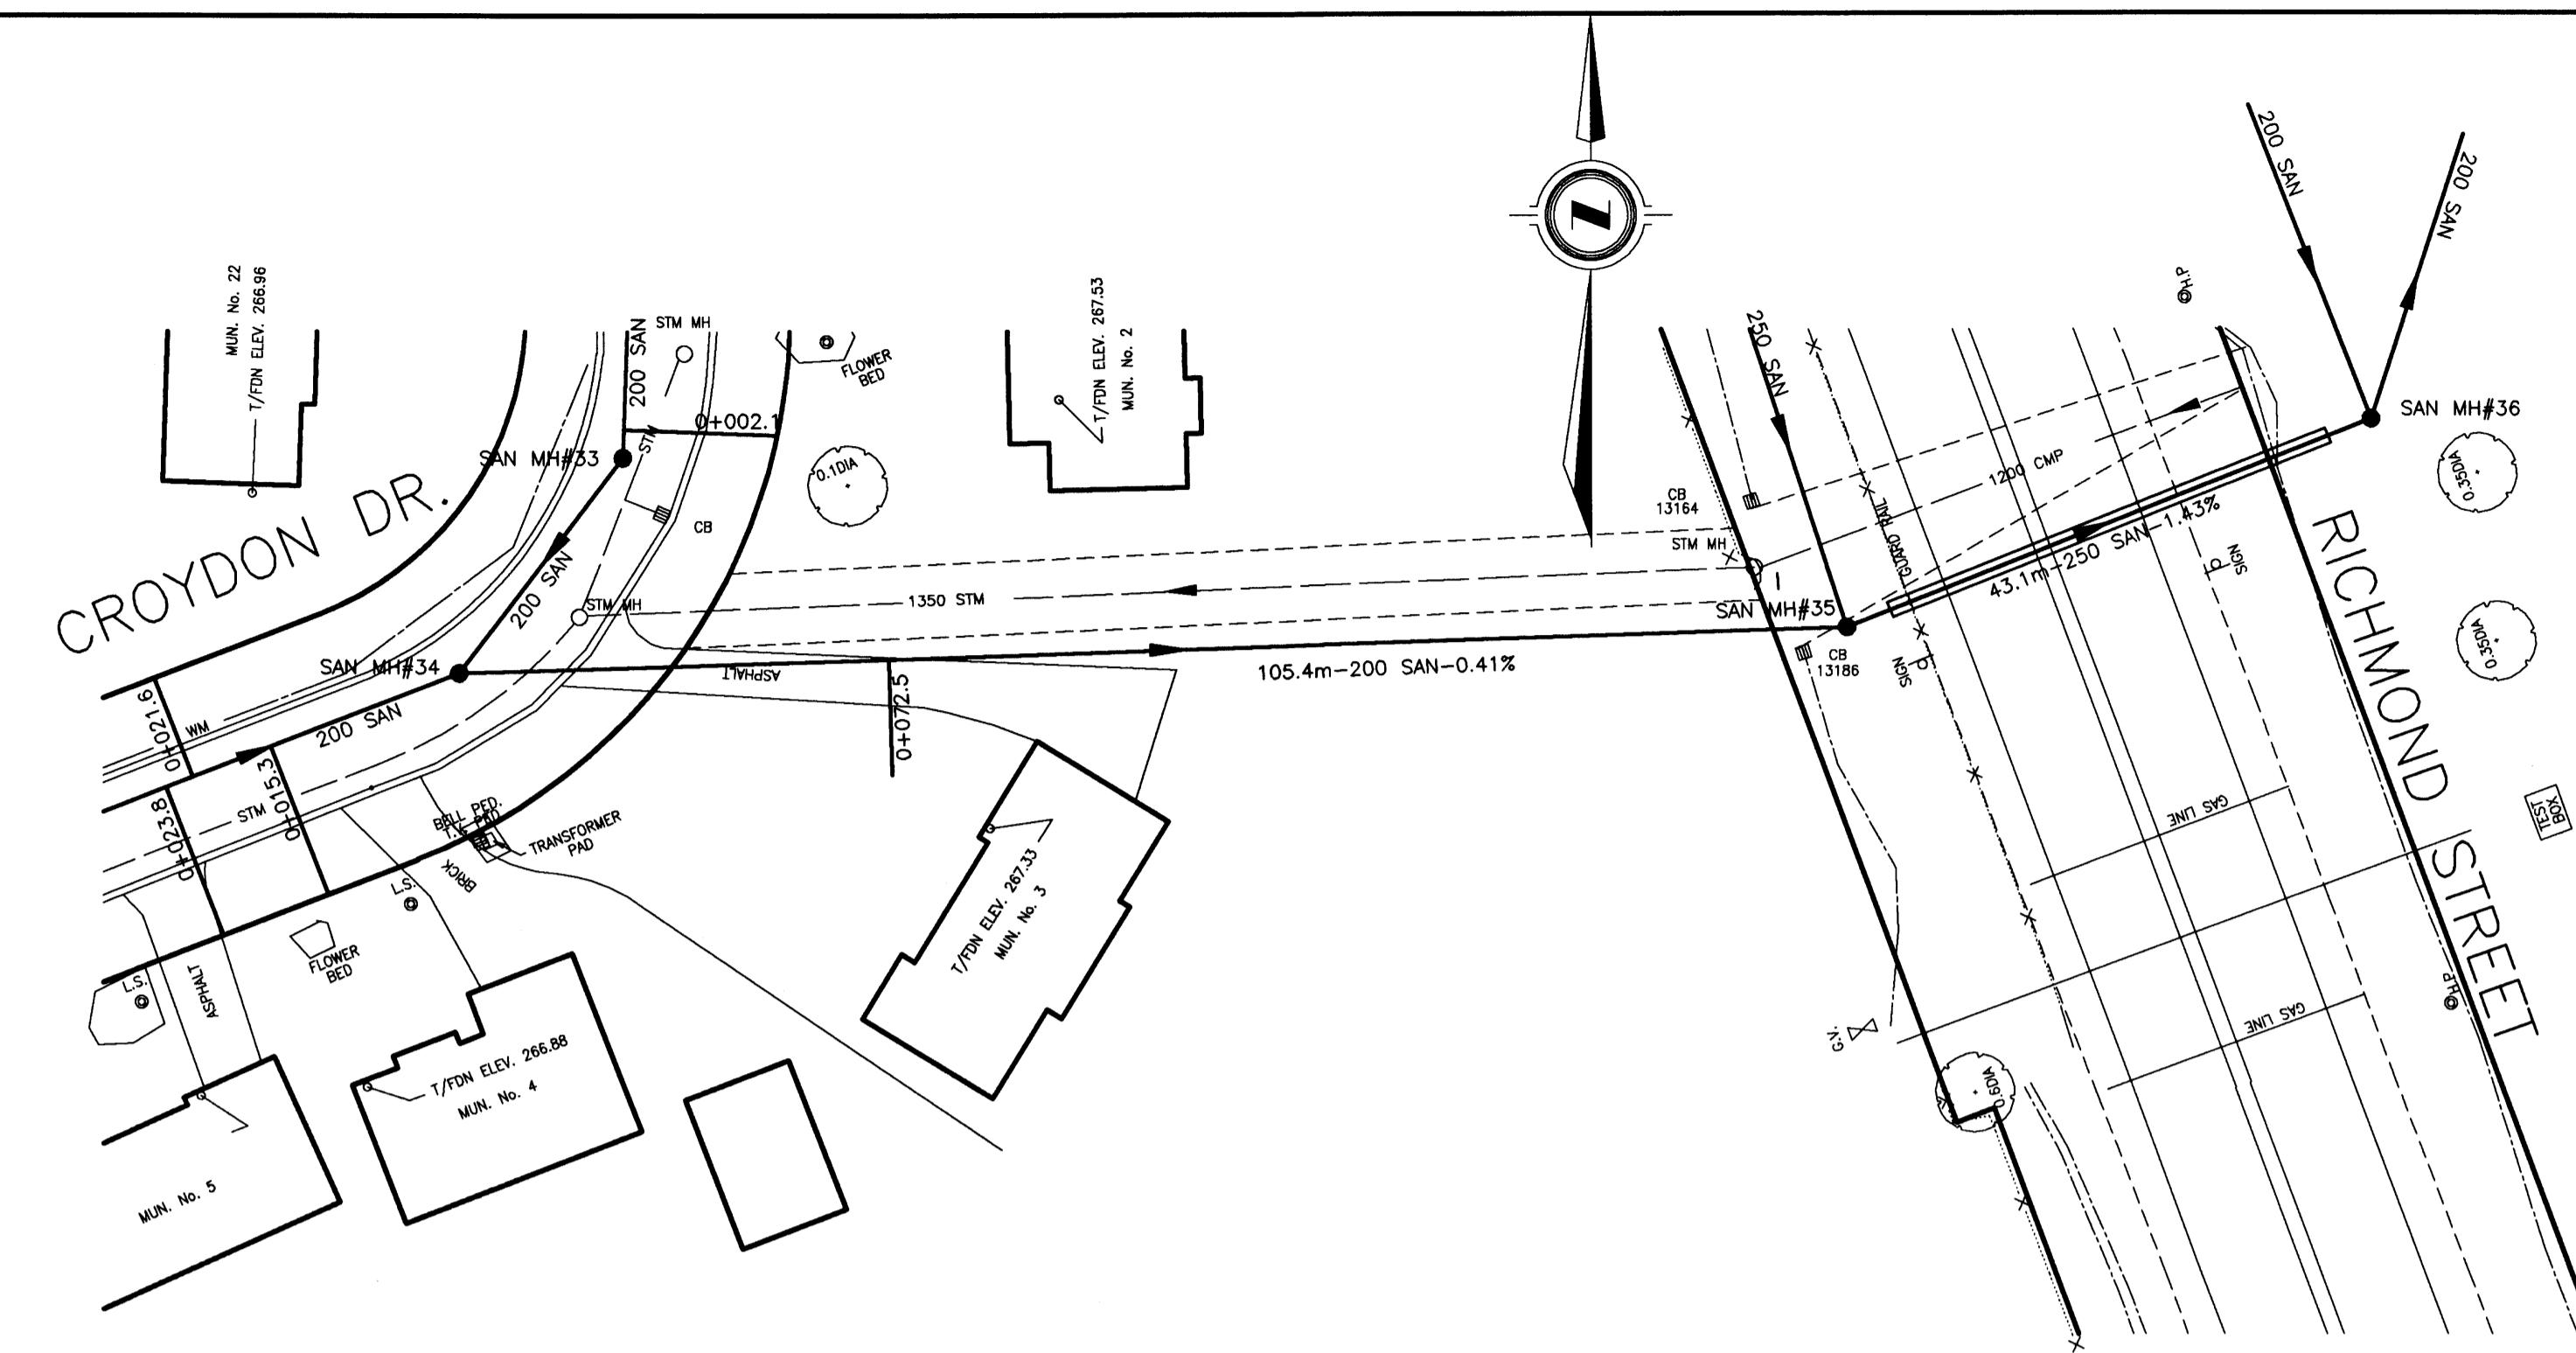




TOWNSHIP  
OF  
MIDDLESEX  
CENTRE

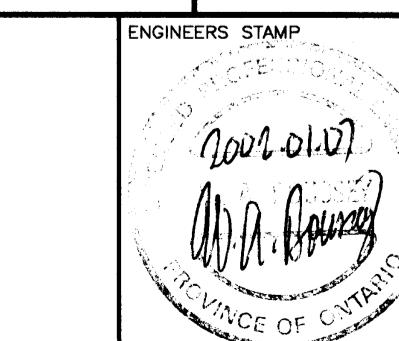ARVA SANITARY SEWAGE SYSTEM  
MURPHY/VEEL PRIVATE LANE - FROM 70m N OF MEDWAY ROAD  
TO MEDWAY ROAD  
BLOCK 'D' - FROM CROYDON DR TO RICHMOND ST



PROJECT No  
00-7278  
SHEET No  
12  
PLAN FILE No

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CONSULTING**

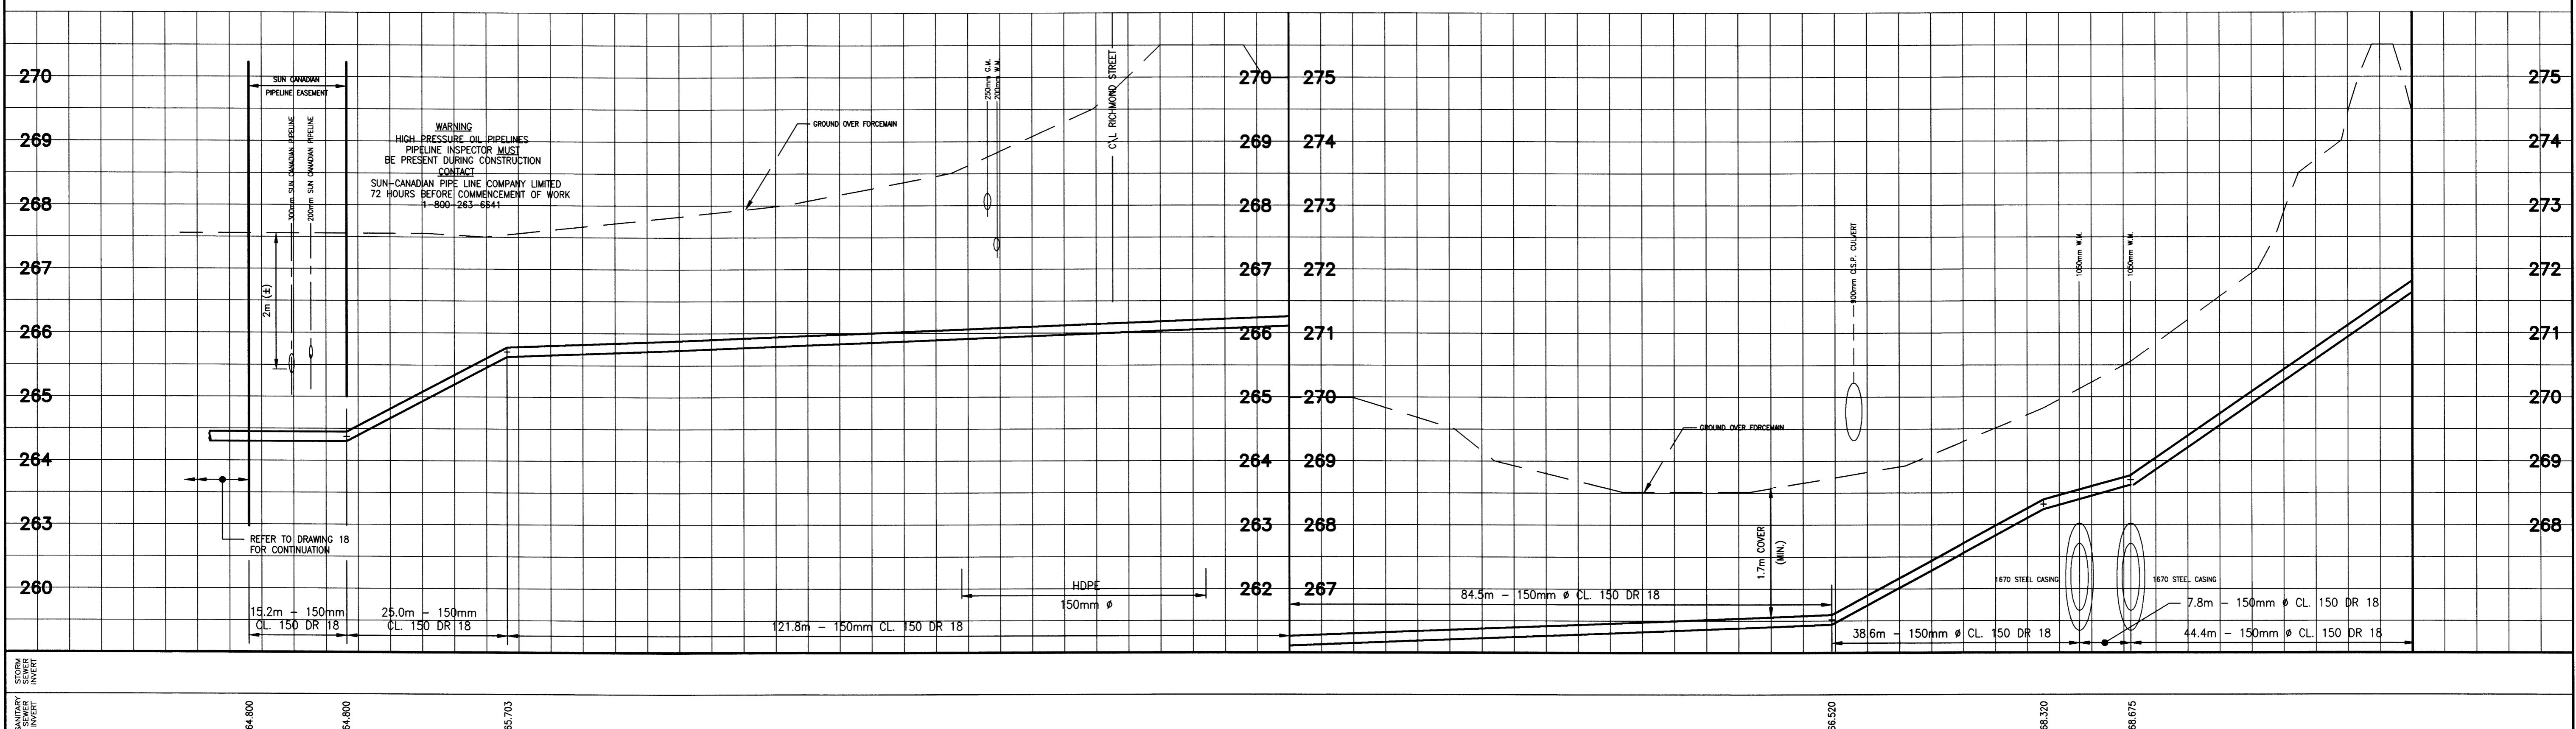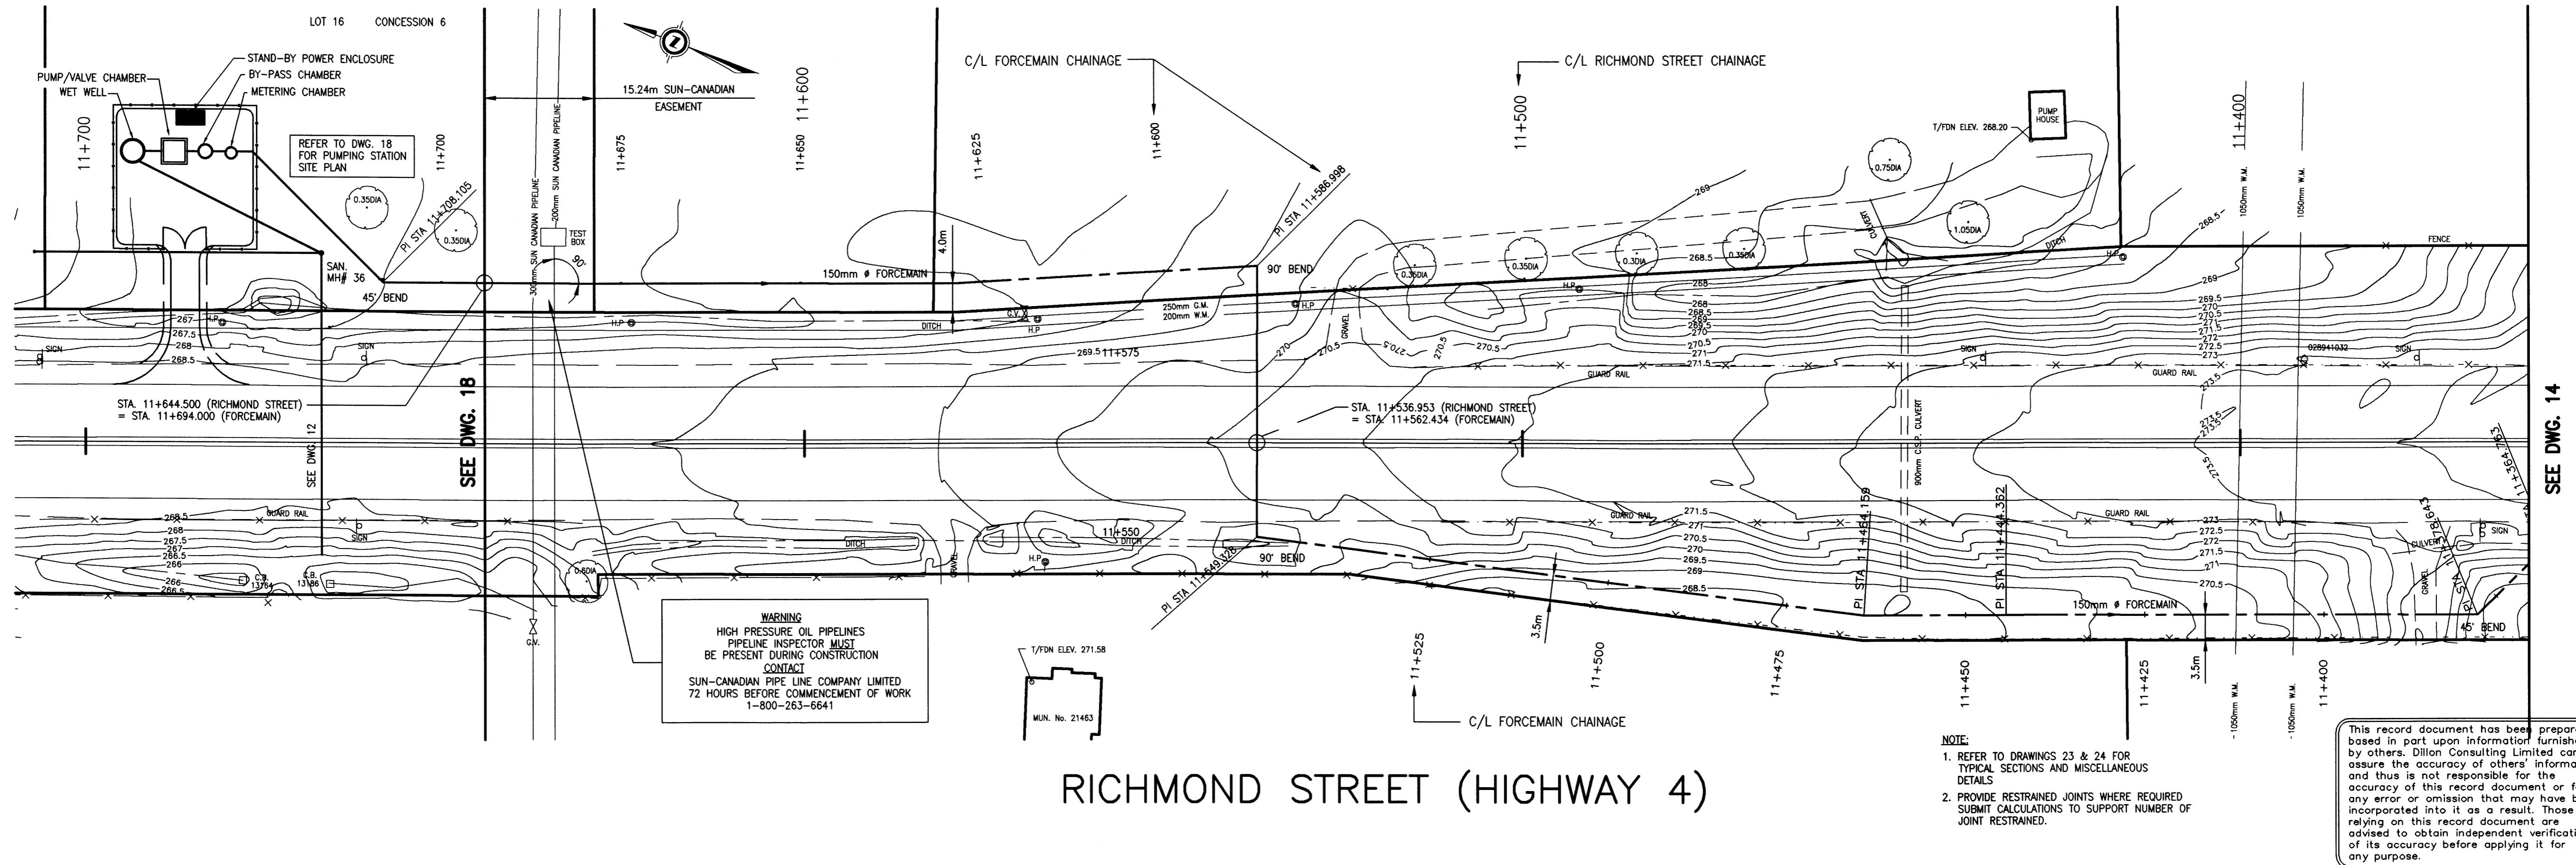

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**TOWNSHIP  
OF  
MIDDLESEX  
CENTRE**

---

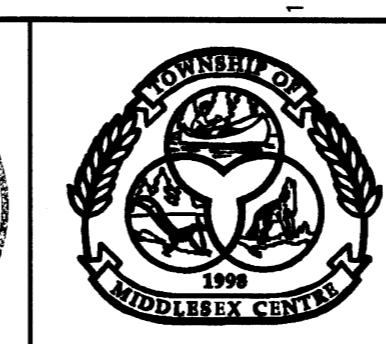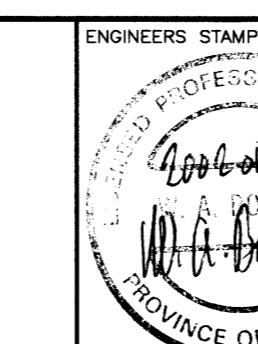11+400

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# ARVA SANITARY SEWAGE SYSTEM


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## FORCEMAIN

FROM PUMPING STATION TO 660m

### NORTH OF SUNNINGDALE ROAD



PROJECT No  
**00-7278**  
SHEET No  
**13**  
PLAN FILE No

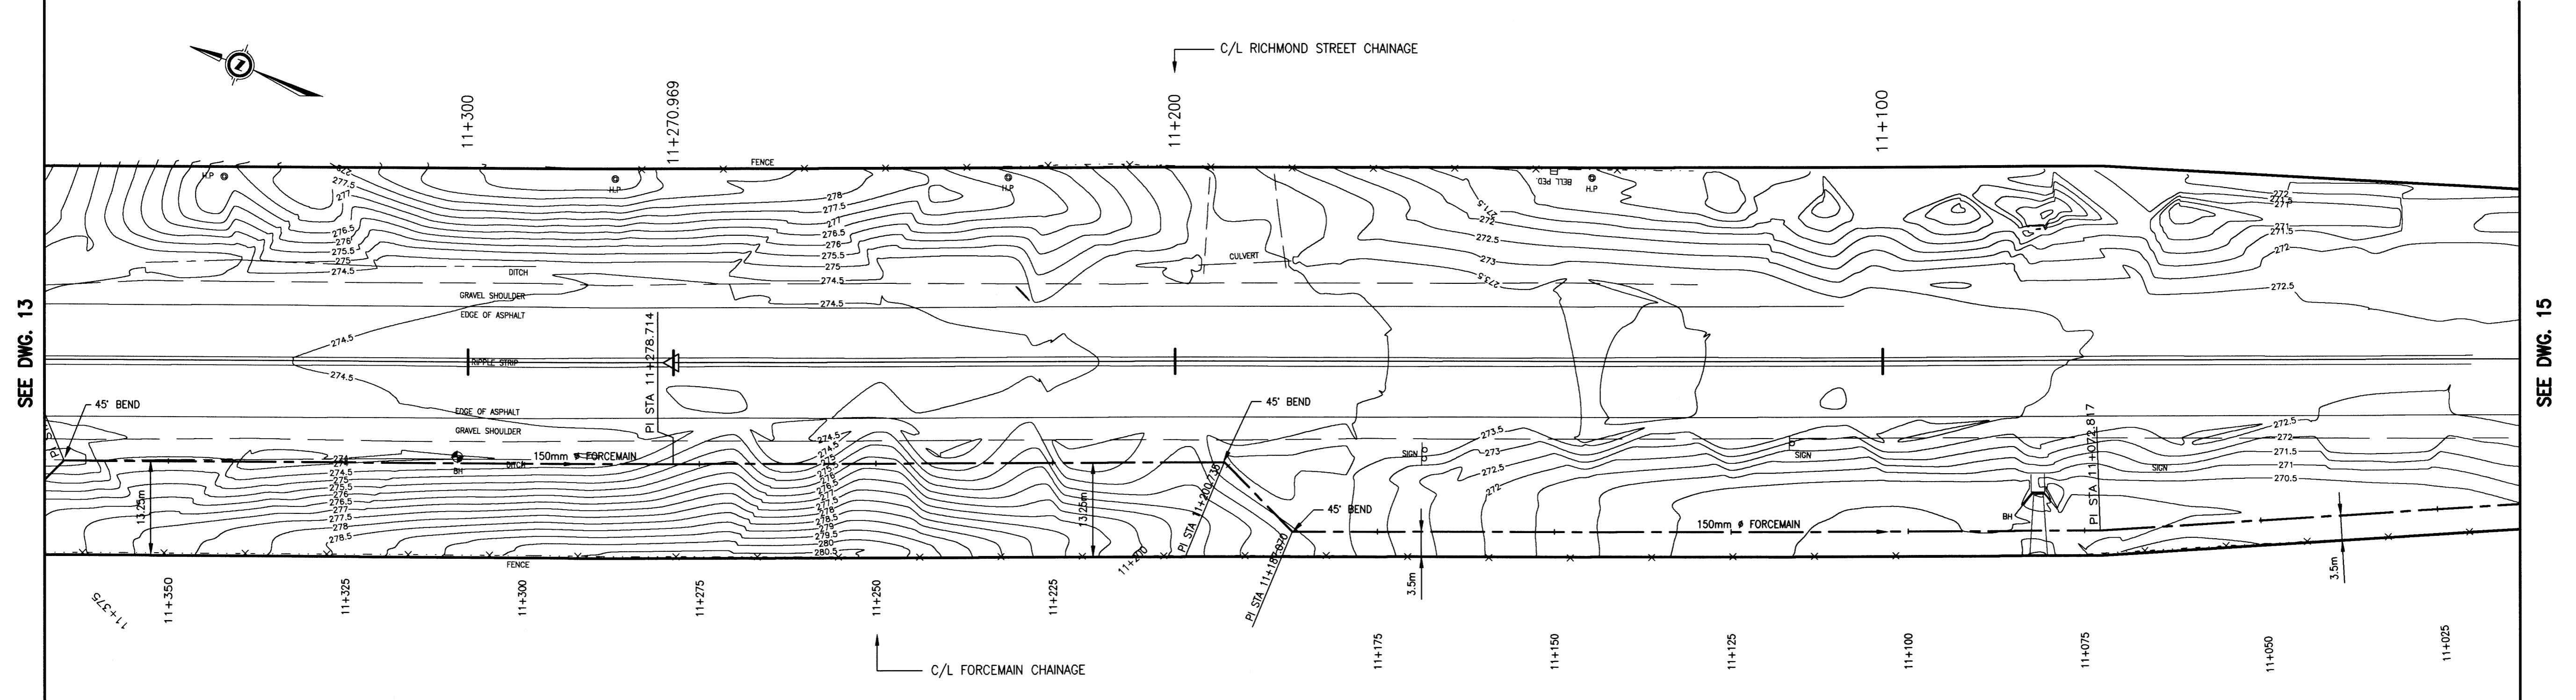

**NOTE:**



1. REFER TO DRAWINGS 23 & 24 FOR TYPICAL SECTIONS AND MISCELLANEOUS DETAILS.
2. PROVIDE RESTRAINED JOINTS WHERE REQUIRED. SUBMIT CALCULATIONS TO SUPPORT NUMBER OF JOINT RESTRAINED.

This record document has been prepared based in part upon information furnished by [REDACTED]. Dillon Consulting Limited cannot assure the accuracy of others' information and thus is not responsible for the accuracy of this record document or for any errors or omissions which may have been introduced into it as a result. Those relying on this record document are advised to obtain independent verification of its accuracy before applying it for any purpose.

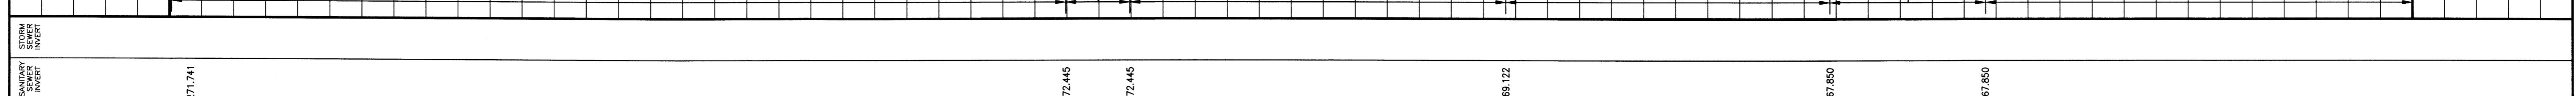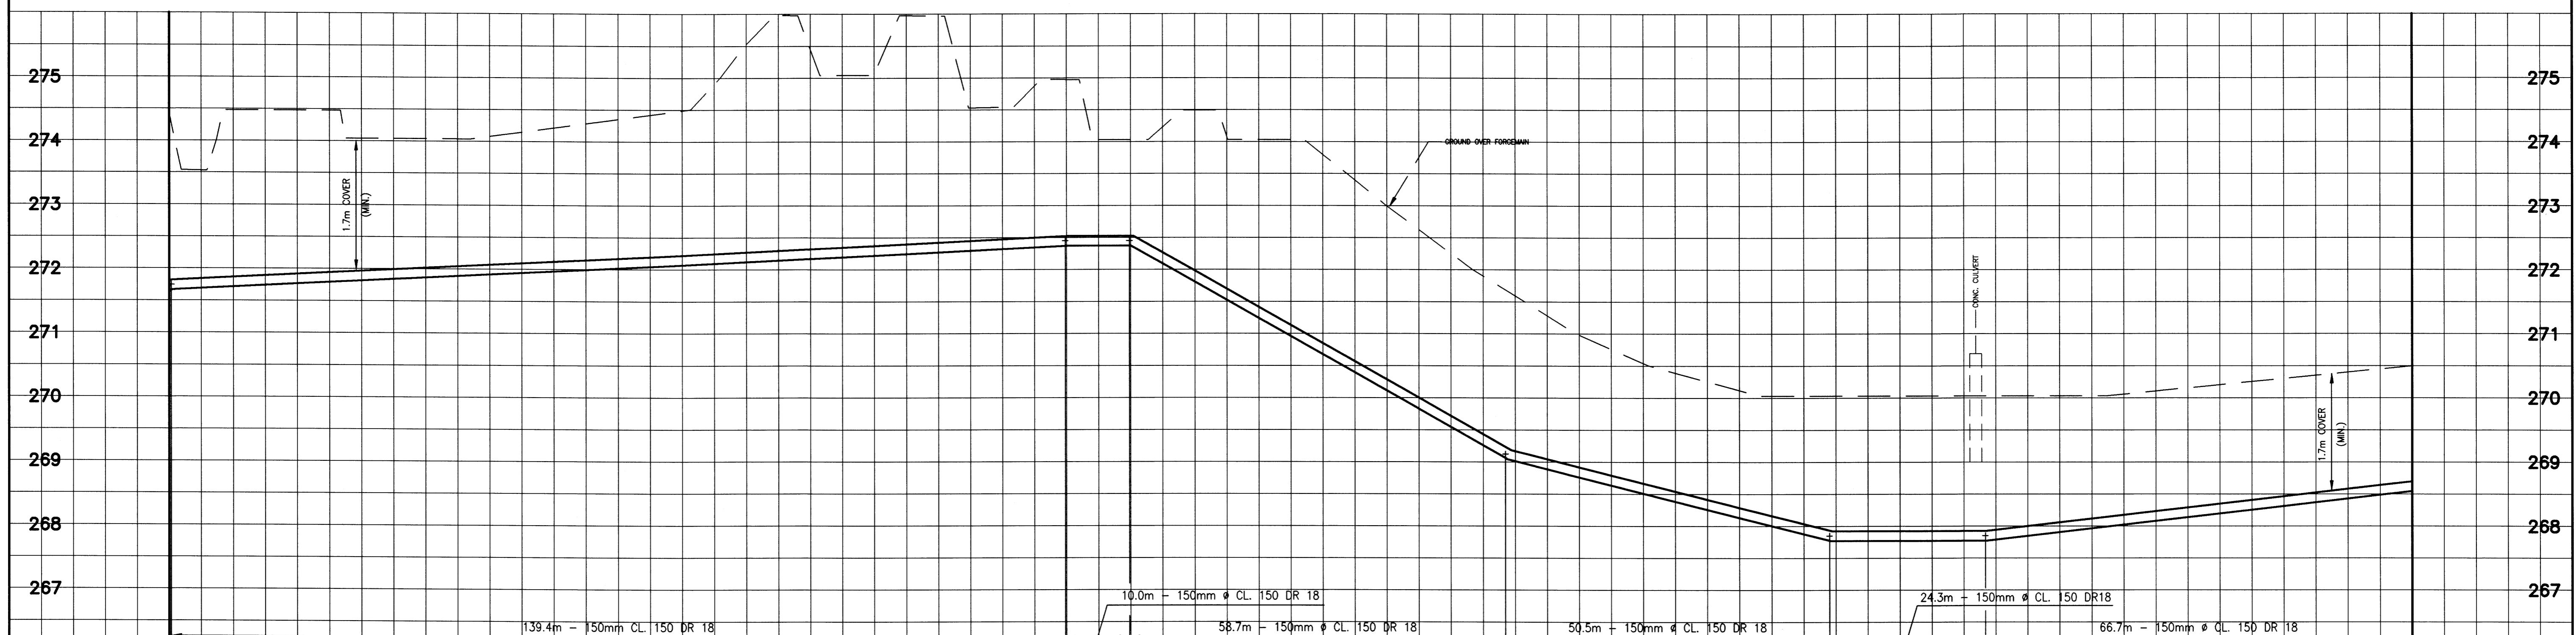

AS CONSTRUCTED NOTES		AS CONSTRUCTED SERVICES		COMPLETION		No	REVISIONS	DATE	BY
1		DESIGN	PAK	1	REVISED FM PROFILE AT WM CROSSING	28/04/00	WAB		
2		DRAWN	PAK	2	AS CONSTRUCTED	NOV/01	WAB		
3		CHECKED	GOH						
4		APPROVED	WAB						
5		DATE	APRIL/2000						

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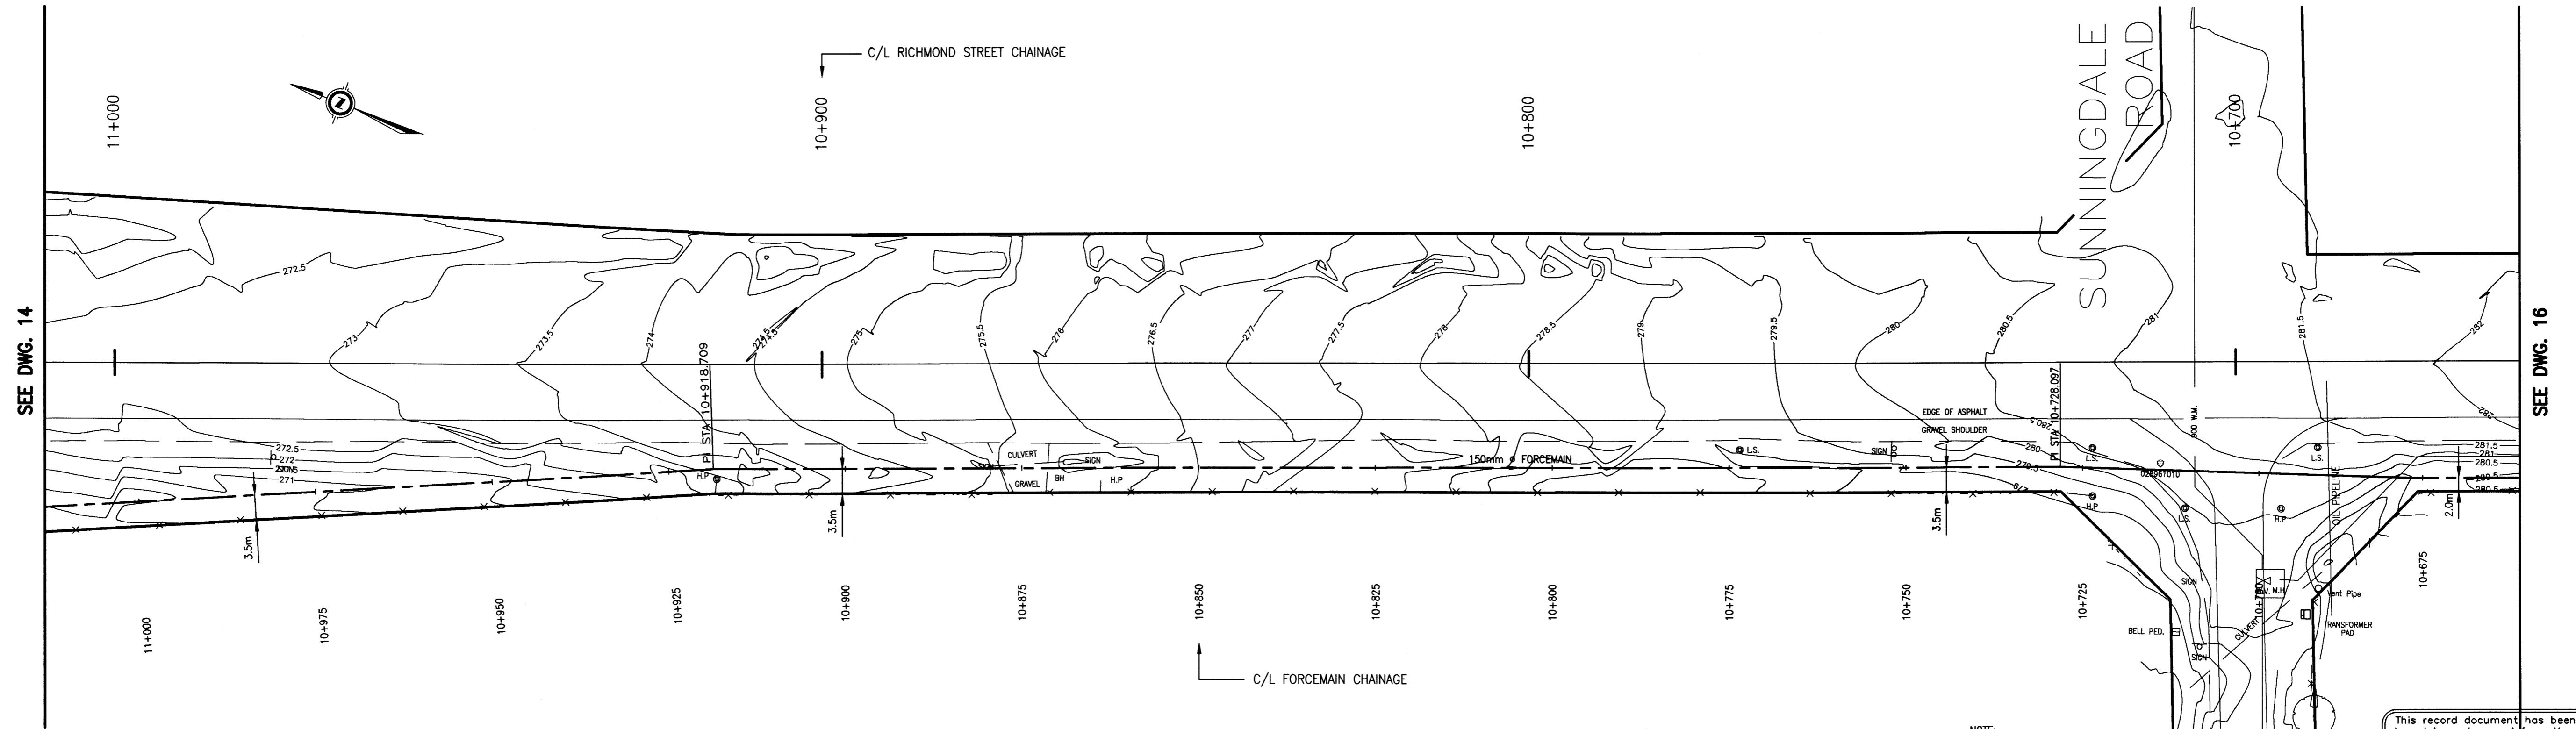


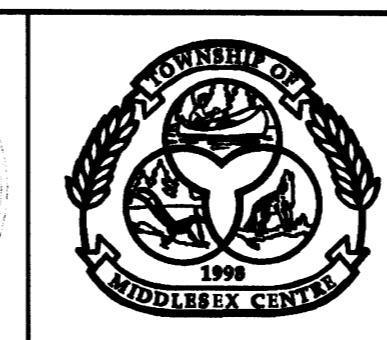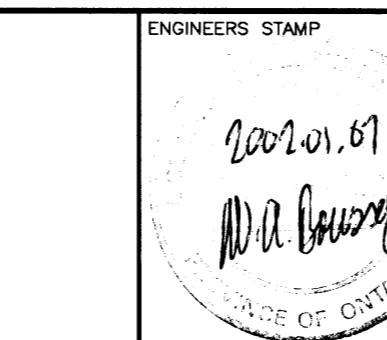TOWNSHIP  
OF  
MIDDLESEX  
CENTRE

SCALE  
1:500  
5.0 0 10m  
HORIZONTAL  
1:50  
0.5 0 1.0m  
VERTICAL

ARVA SANITARY SEWAGE SYSTEM  
FORCEMAIN  
FROM 660m NORTH OF SUNNINGDALE ROAD  
TO 300m NORTH OF SUNNINGDALE ROAD


PROJECT No  
00-7278  
SHEET No  
14  
PLAN FILE No



## RICHMOND STREET

**NOTE:**  
 1. REFER TO DRAWINGS 23 & 24 FOR  
 TYPICAL SECTIONS AND MISCELLANEOUS  
 DETAILS  
 2. PROVIDE RESTRAINED JOINTS WHERE REQUIRED  
 SUBMIT CALCULATIONS TO SUPPORT NUMBER OF  
 JOINT RESTRAINED.



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STATION	C/ ROAD ELEV.	STORM SEWER INVERT	SEWER ELEV.	SEWER INVERT	269.316	271.419	275.788	276.987	278.429
11+000									
10+900									
10+850									
10+800									
10+750									
10+700									

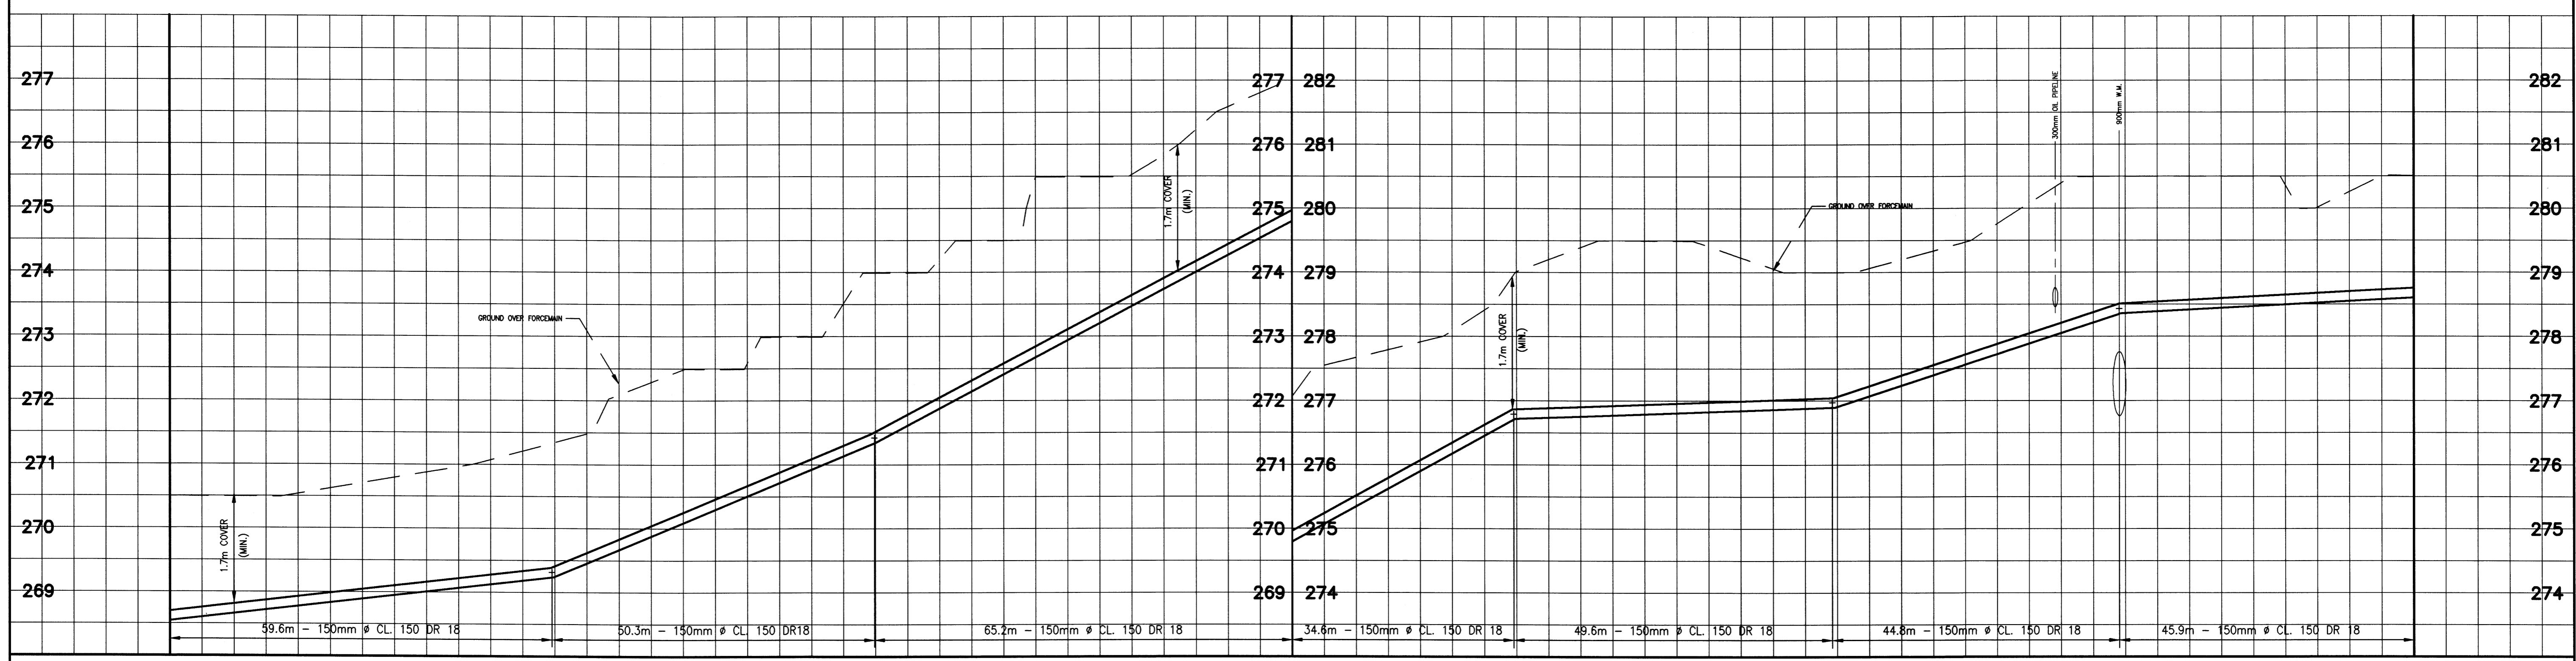AS CONSTRUCTED NOTES	AS CONSTRUCTED SERVICES	COMPLETION	No	REVISIONS		DATE	BY
				DESIGN	PAK		
1			1	REVISED FM PROFILE AT WM CROSSING	28/04/00	WAB	
2			2	AS CONSTRUCTED		NOV/01	WAB
3							
4							
5							

**DILLON**  
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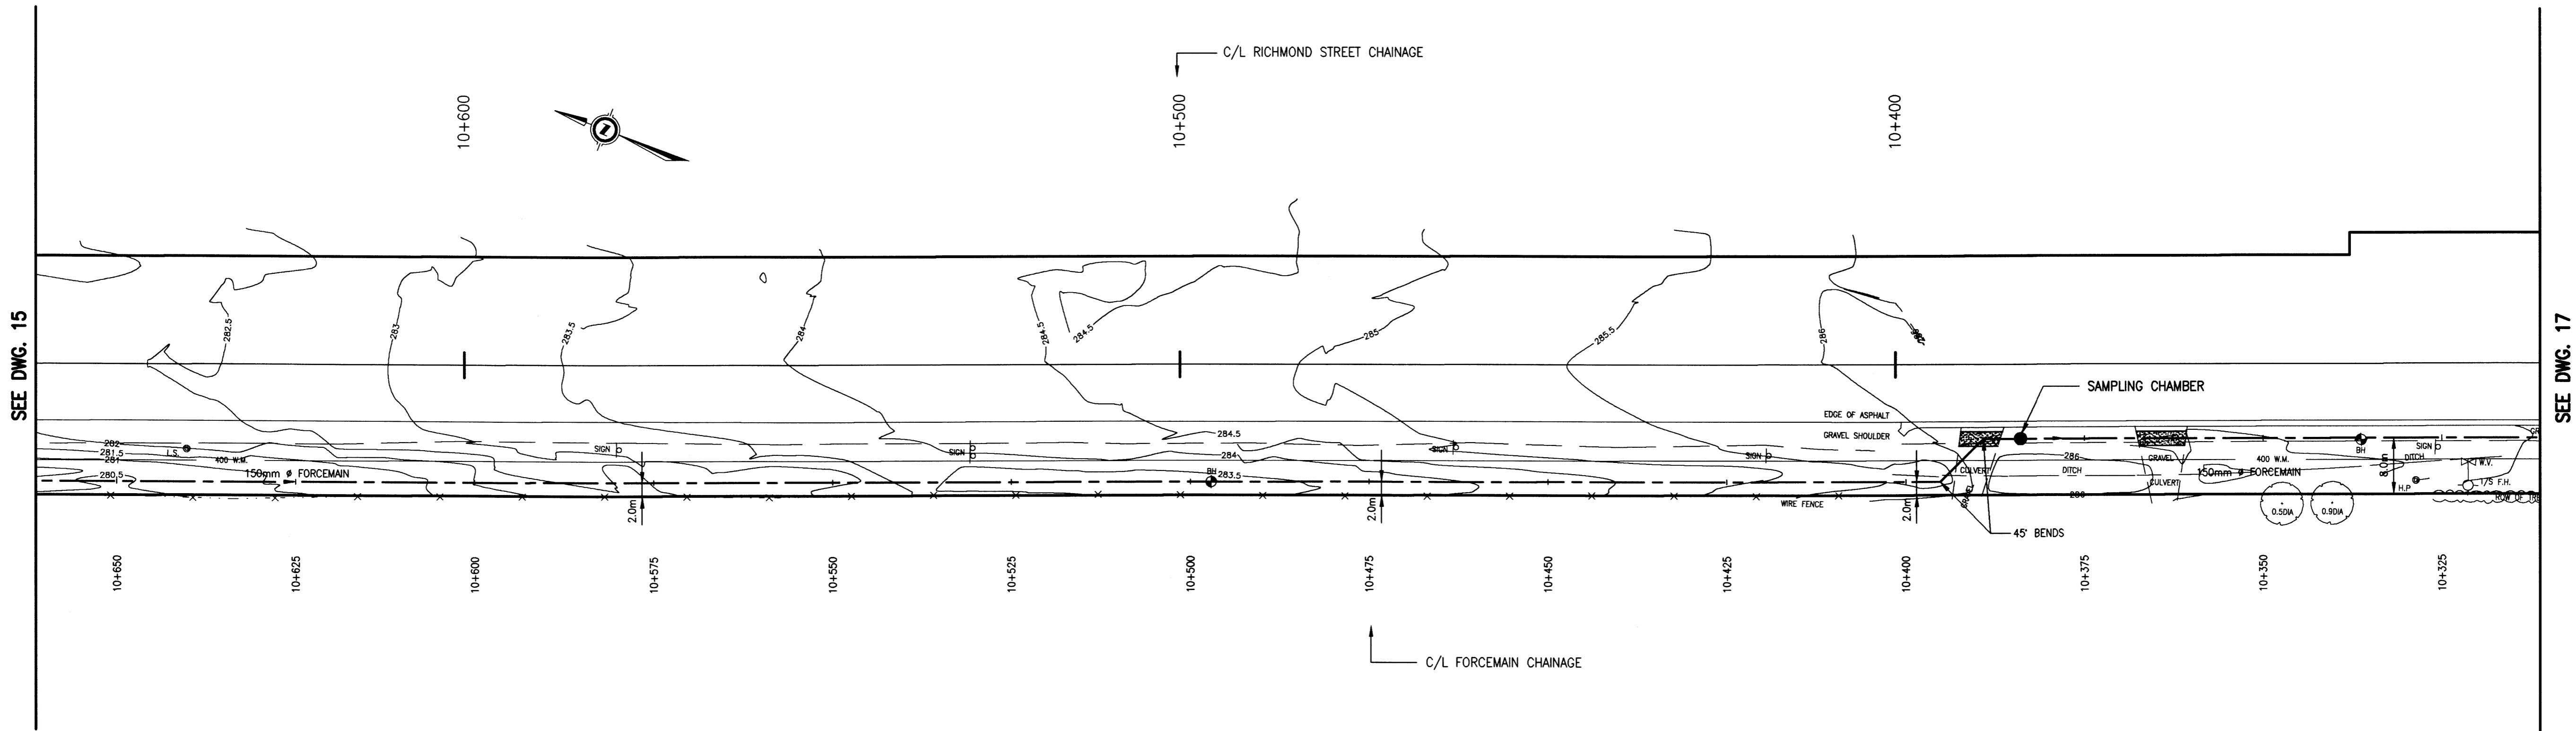


**TOWNSHIP  
OF  
MIDDLESEX  
CENTRE**

SCALE  
 5.0 0 10m  
 HORIZONTAL  
 0.5 0 1.0m  
 VERTICAL

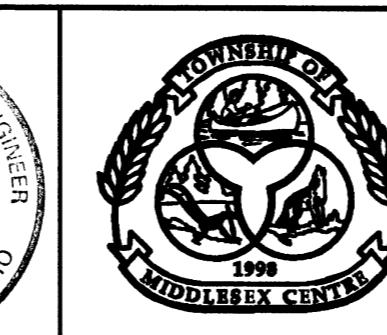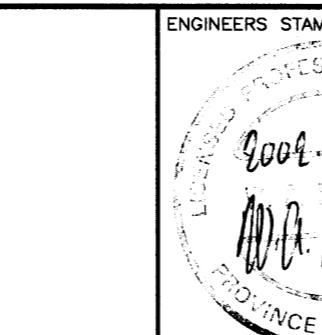**ARVA SANITARY SEWAGE SYSTEM**  
**FORCEMAIN**  
 FROM 300m NORTH OF SUNNINGDALE ROAD  
 TO SUNNINGDALE ROAD


PROJECT No  
**00-7278**  
 SHEET No  
**15**  
 PLAN FILE No



**NOTE:**

1. REFER TO DRAWINGS 23 & 24 FOR TYPICAL SECTIONS AND MISCELLANEOUS DETAILS.
2. PROVIDE RESTRAINED JOINTS WHERE REQUIRED. SUBMIT CALCULATIONS TO SUPPORT NUMBER OF JOINT RESTRAINED.

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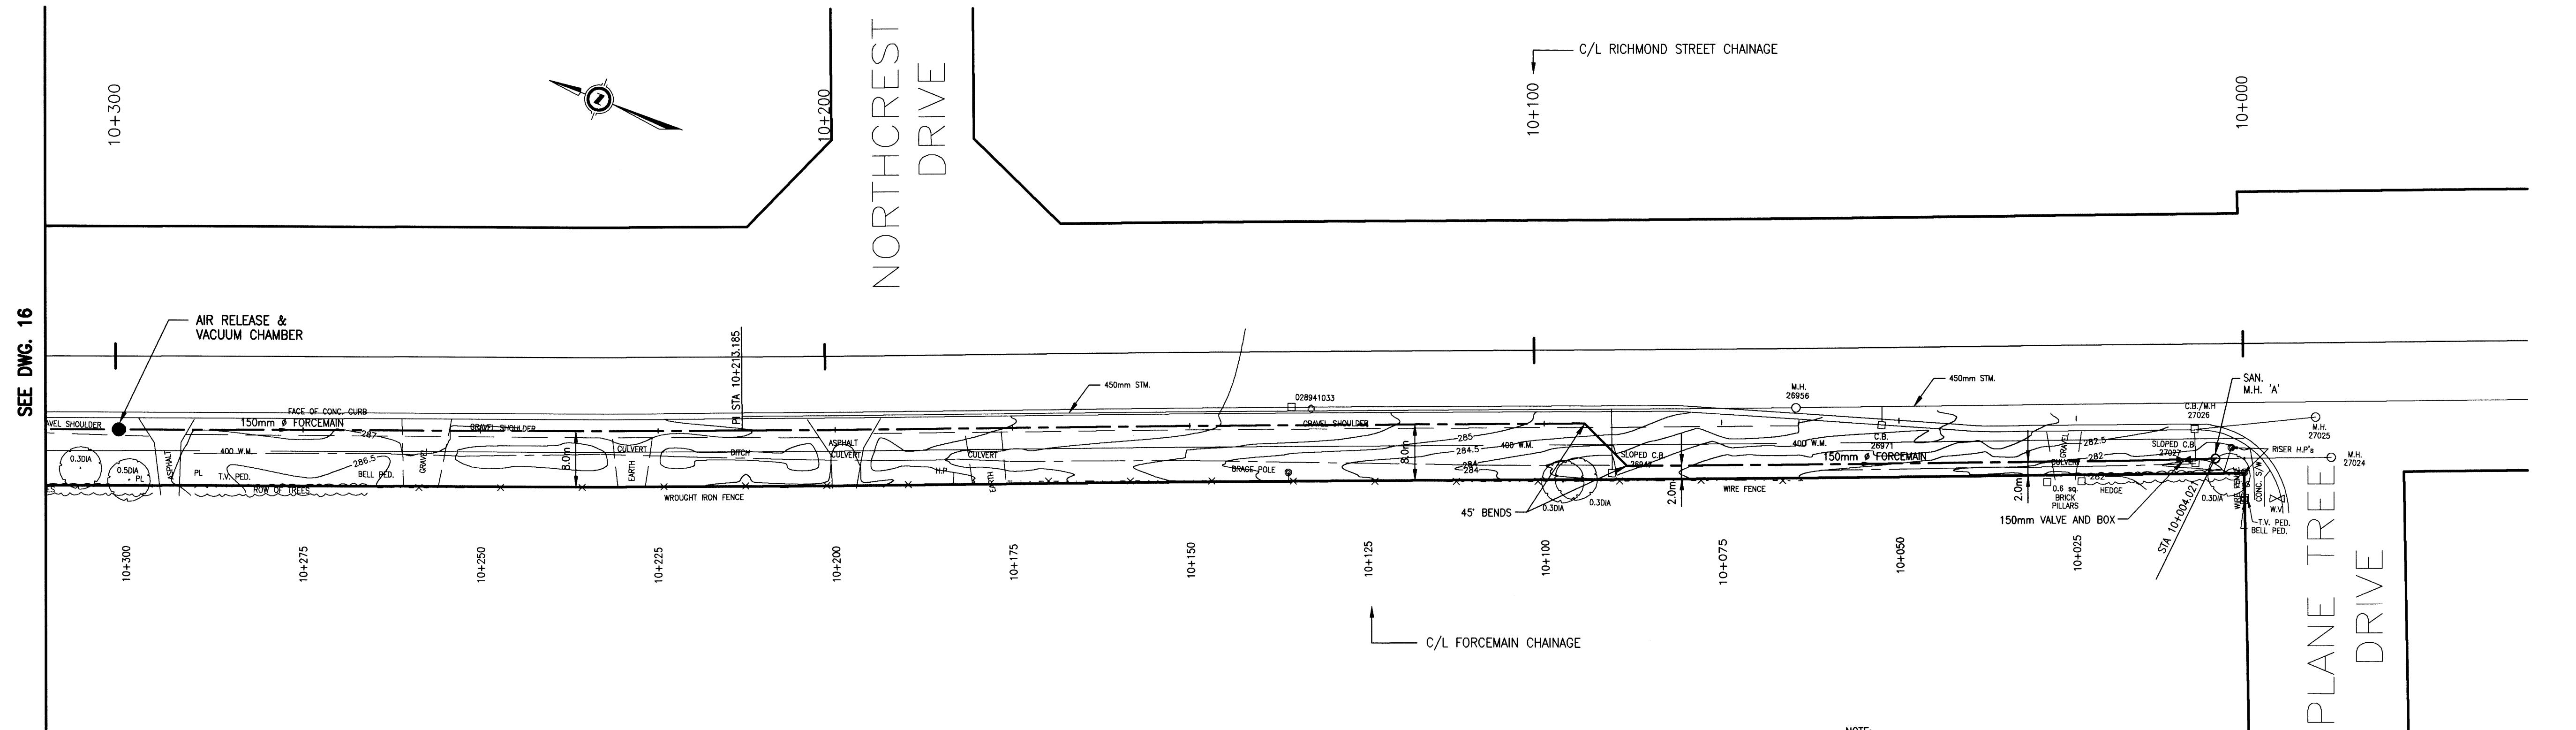
AS CONSTRUCTED NOTES	AS CONSTRUCTED SERVICES	COMPLETION	No	REVISIONS	DATE	BY	ENGINEERS STAMP	TOWNSHIP OF MIDDLESEX CENTRE	ARVA SANITARY SEWAGE SYSTEM	PROJECT No
1	DESIGN PAK	1	REVISED FM PROFILE AT WM CROSSING	28/04/00	WAB				FORCemain FROM SUNNINGDALE ROAD TO 300m NORTH OF PLANE TREE DRIVE	00-7278
2	DRAWN PAK	2	AS CONSTRUCTED	NOV/01	WAB					
3	CHECKED GOH									
4	APPROVED WAB									
5	DATE APRIL/2000									

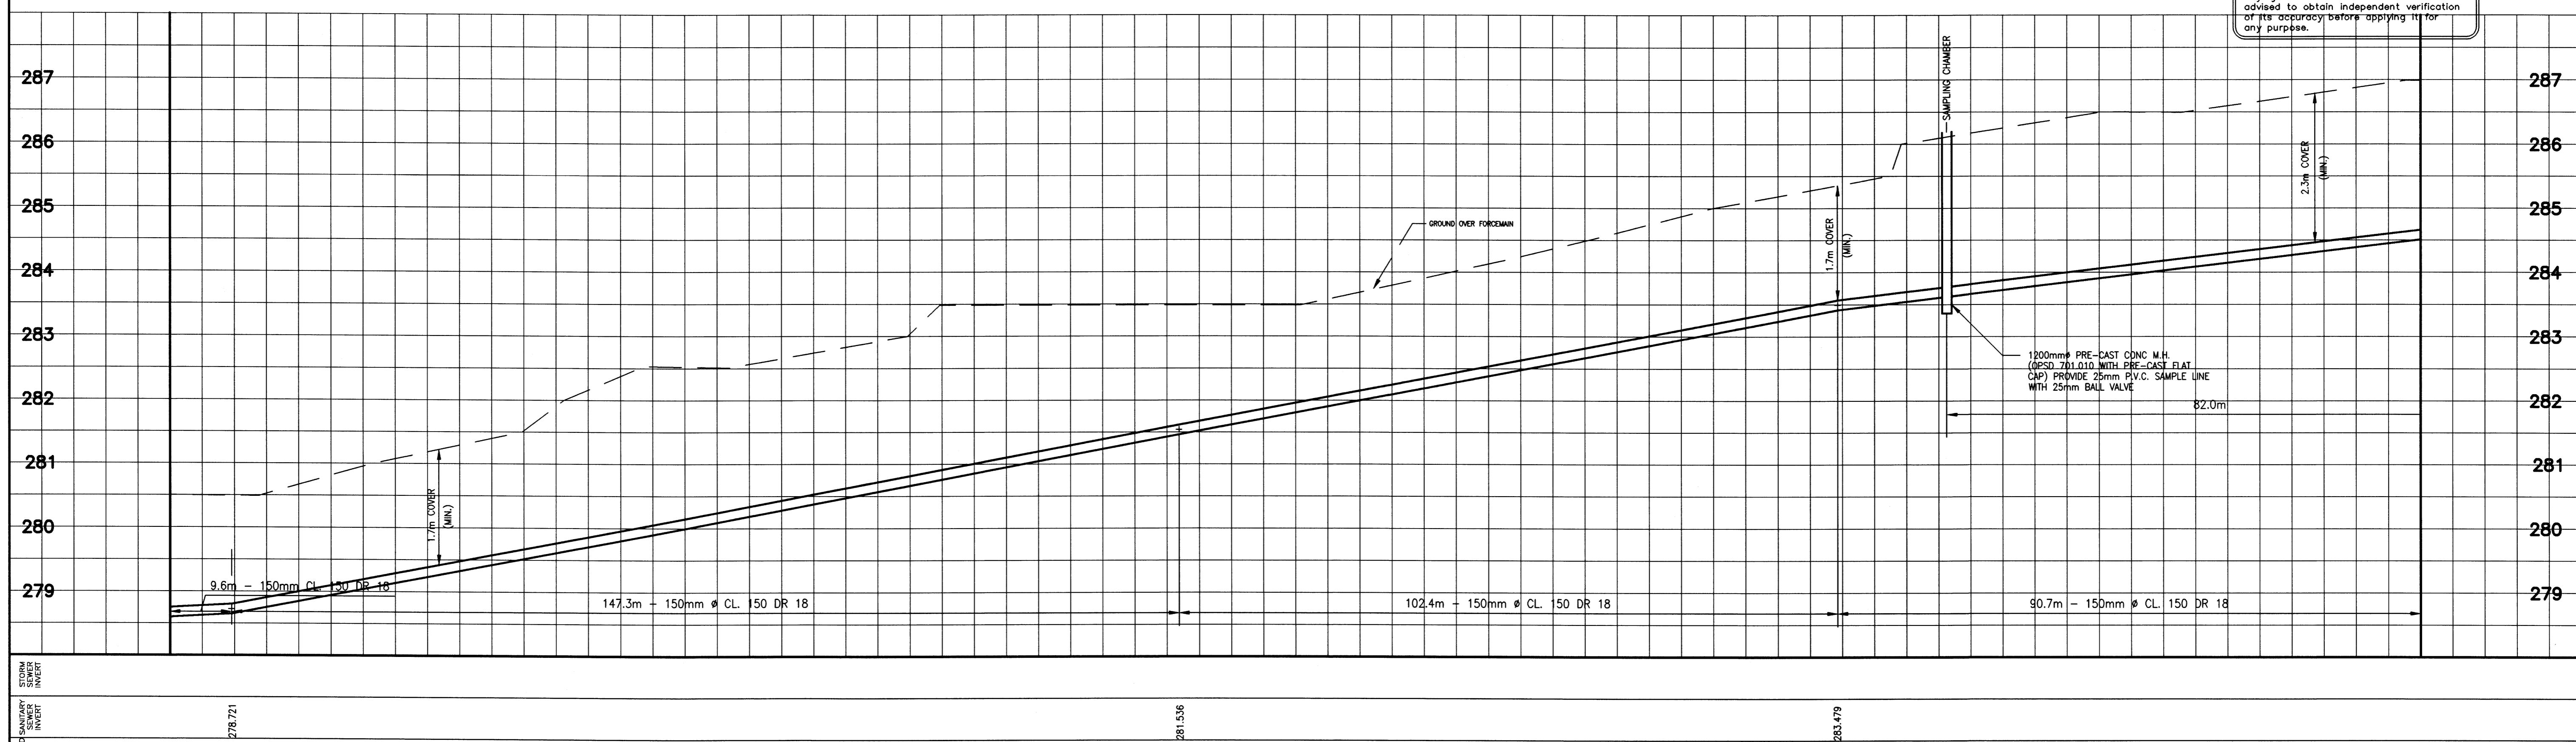**DILLON**  
CONSULTING

SCALE  
5.0 0 10m  
HORIZONTAL  
1:50  
0.5 0 1.0m  
VERTICAL

SHEET No  
16

PLAN FILE NO





# RICHMOND STREET

NOTE:

1. REFER TO DRAWINGS 23 & 24 FOR TYPICAL SECTIONS AND MISCELLANEOUS DETAILS
2. PROVIDE RESTRAINED JOINTS WHERE REQUIRED  
SUBMIT CALCULATIONS TO SUPPORT NUMBER OF JOINT RESTRAINED.

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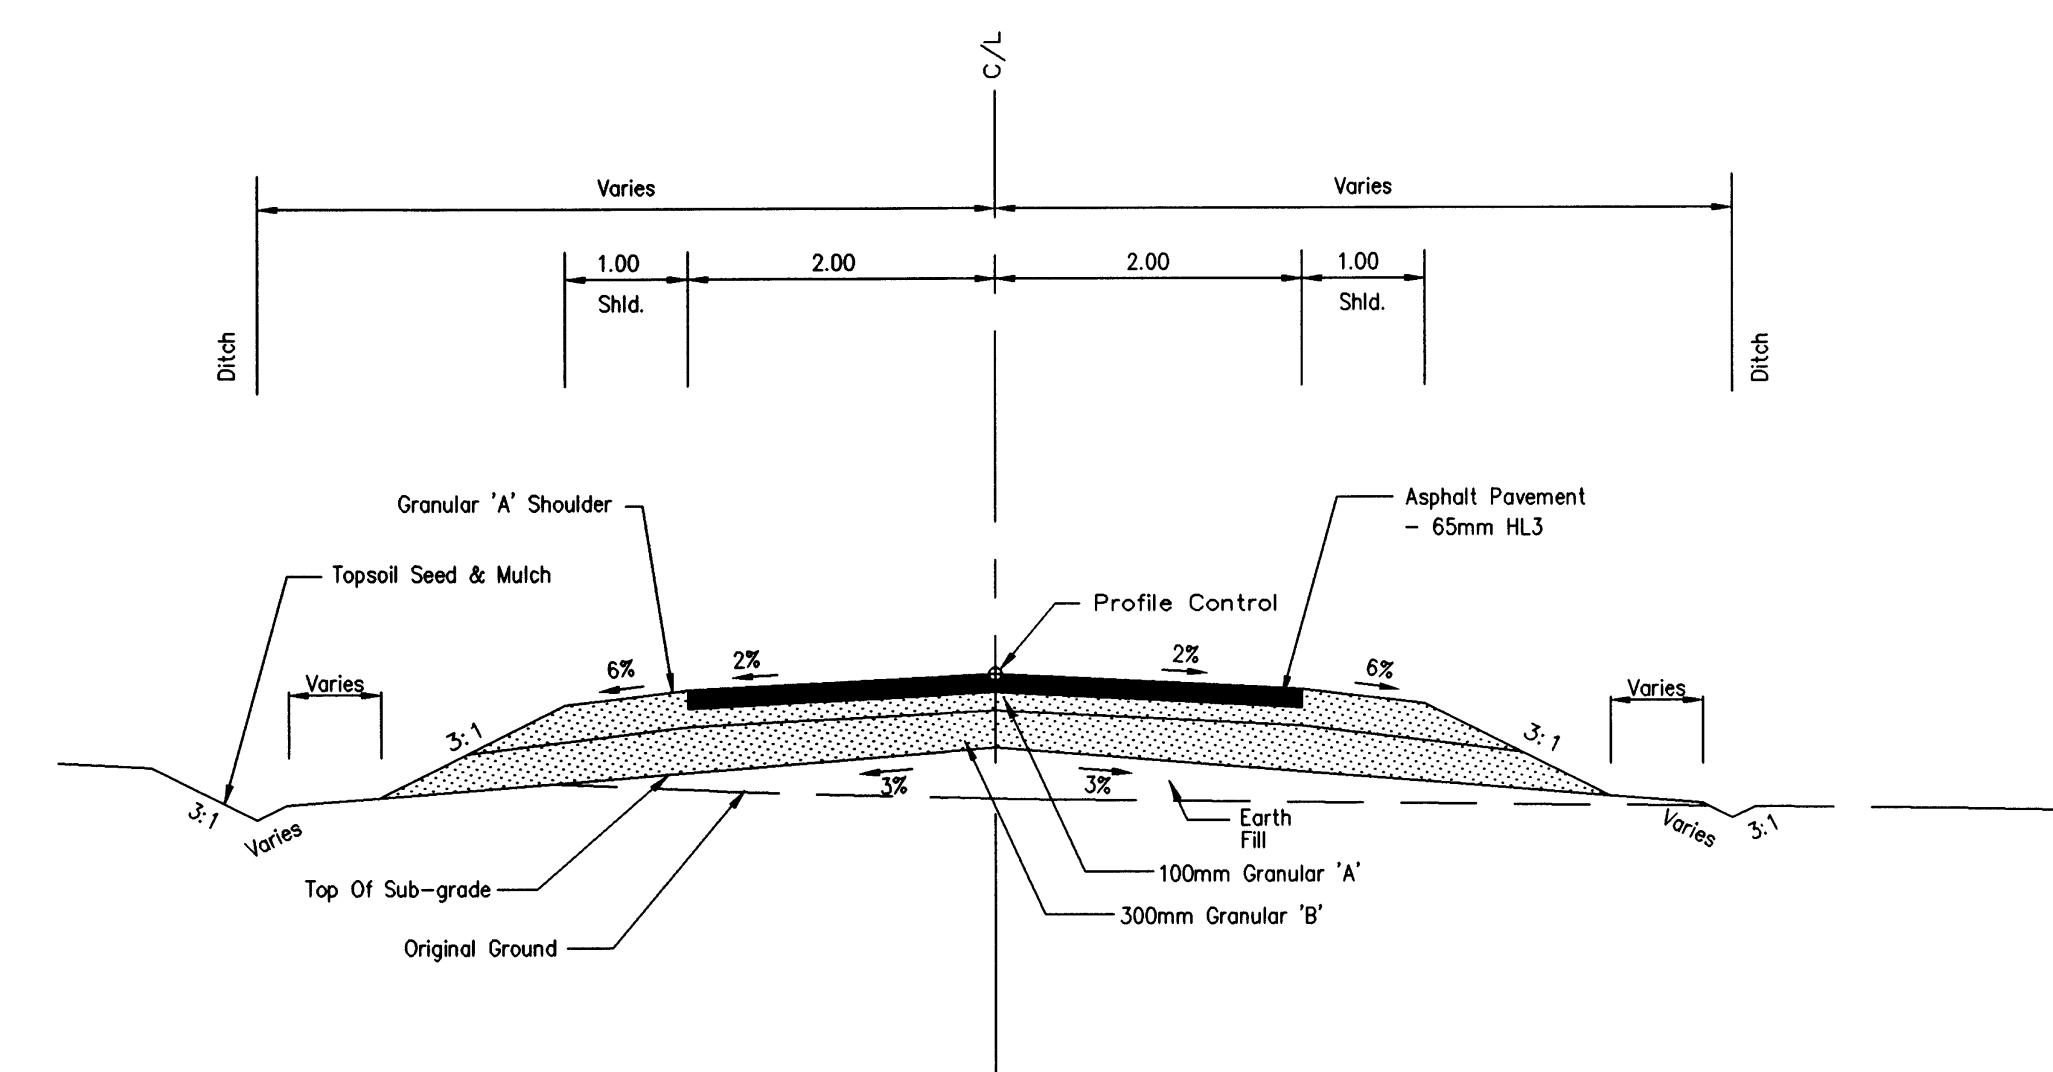
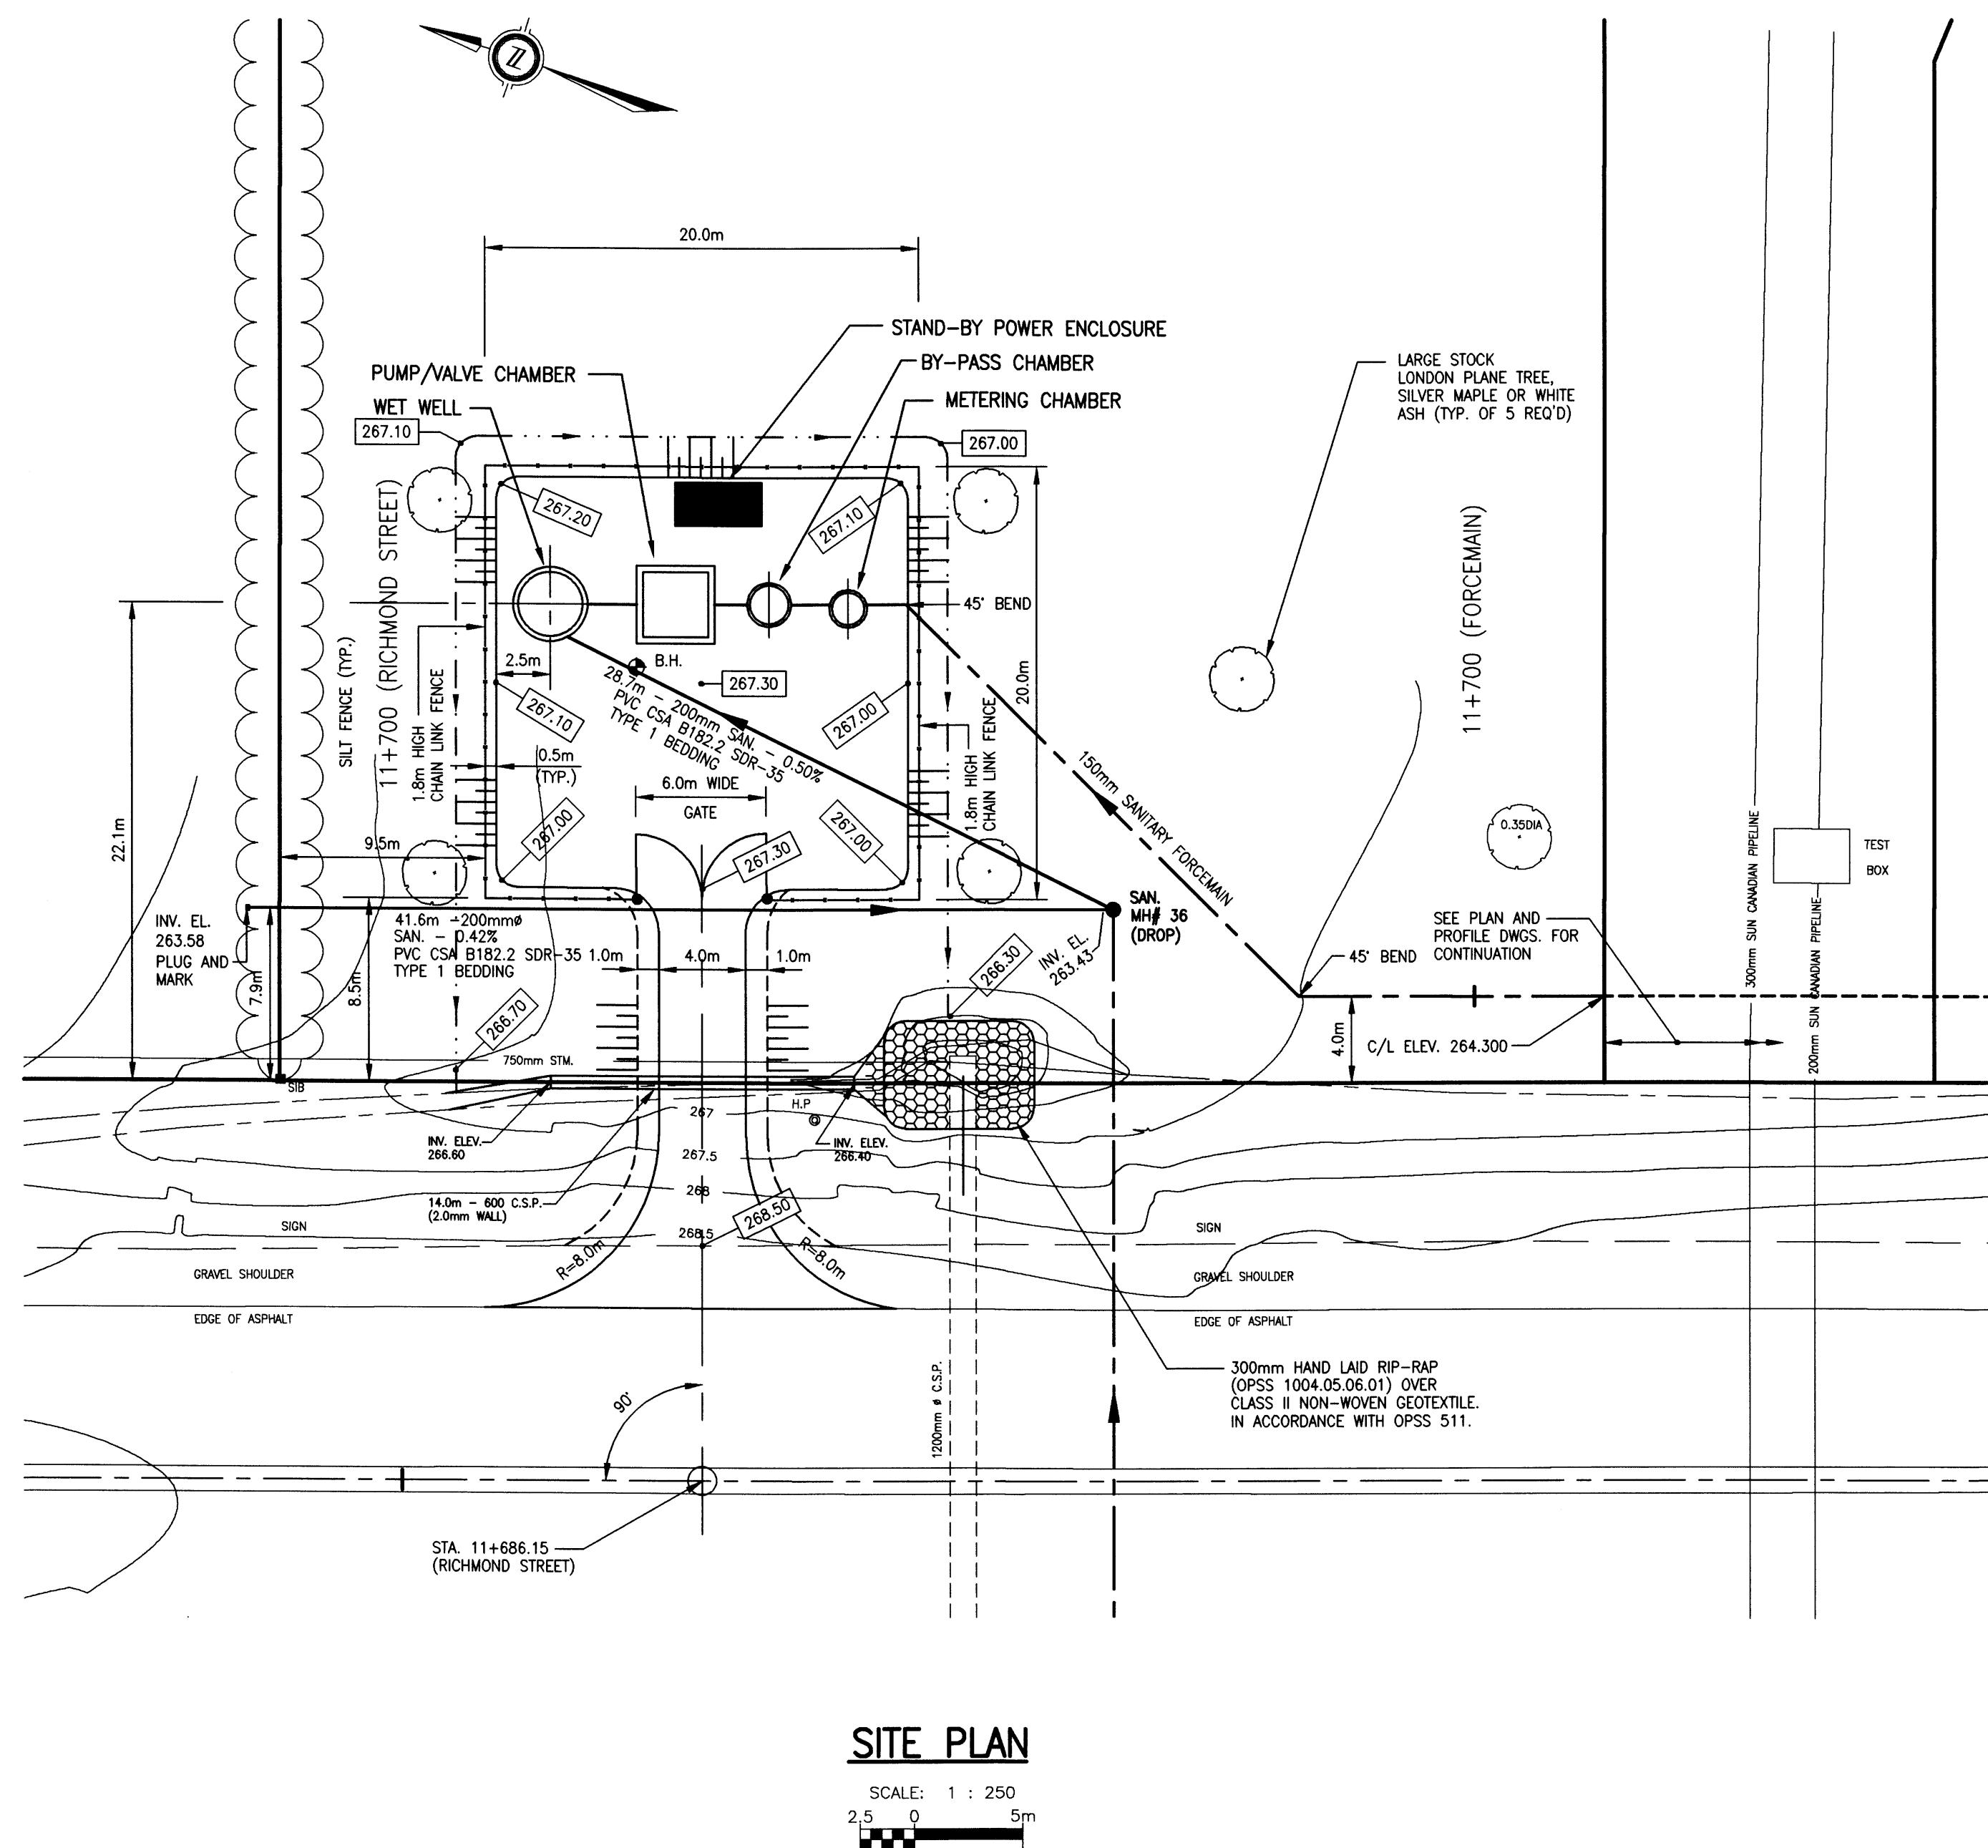
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**TOWNSHIP  
OF  
MIDDLESEX  
CENTRE**

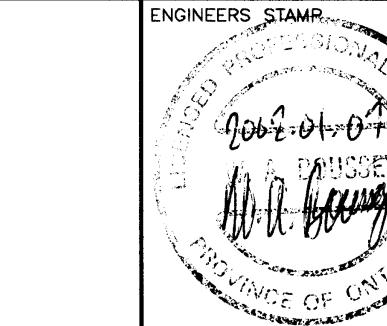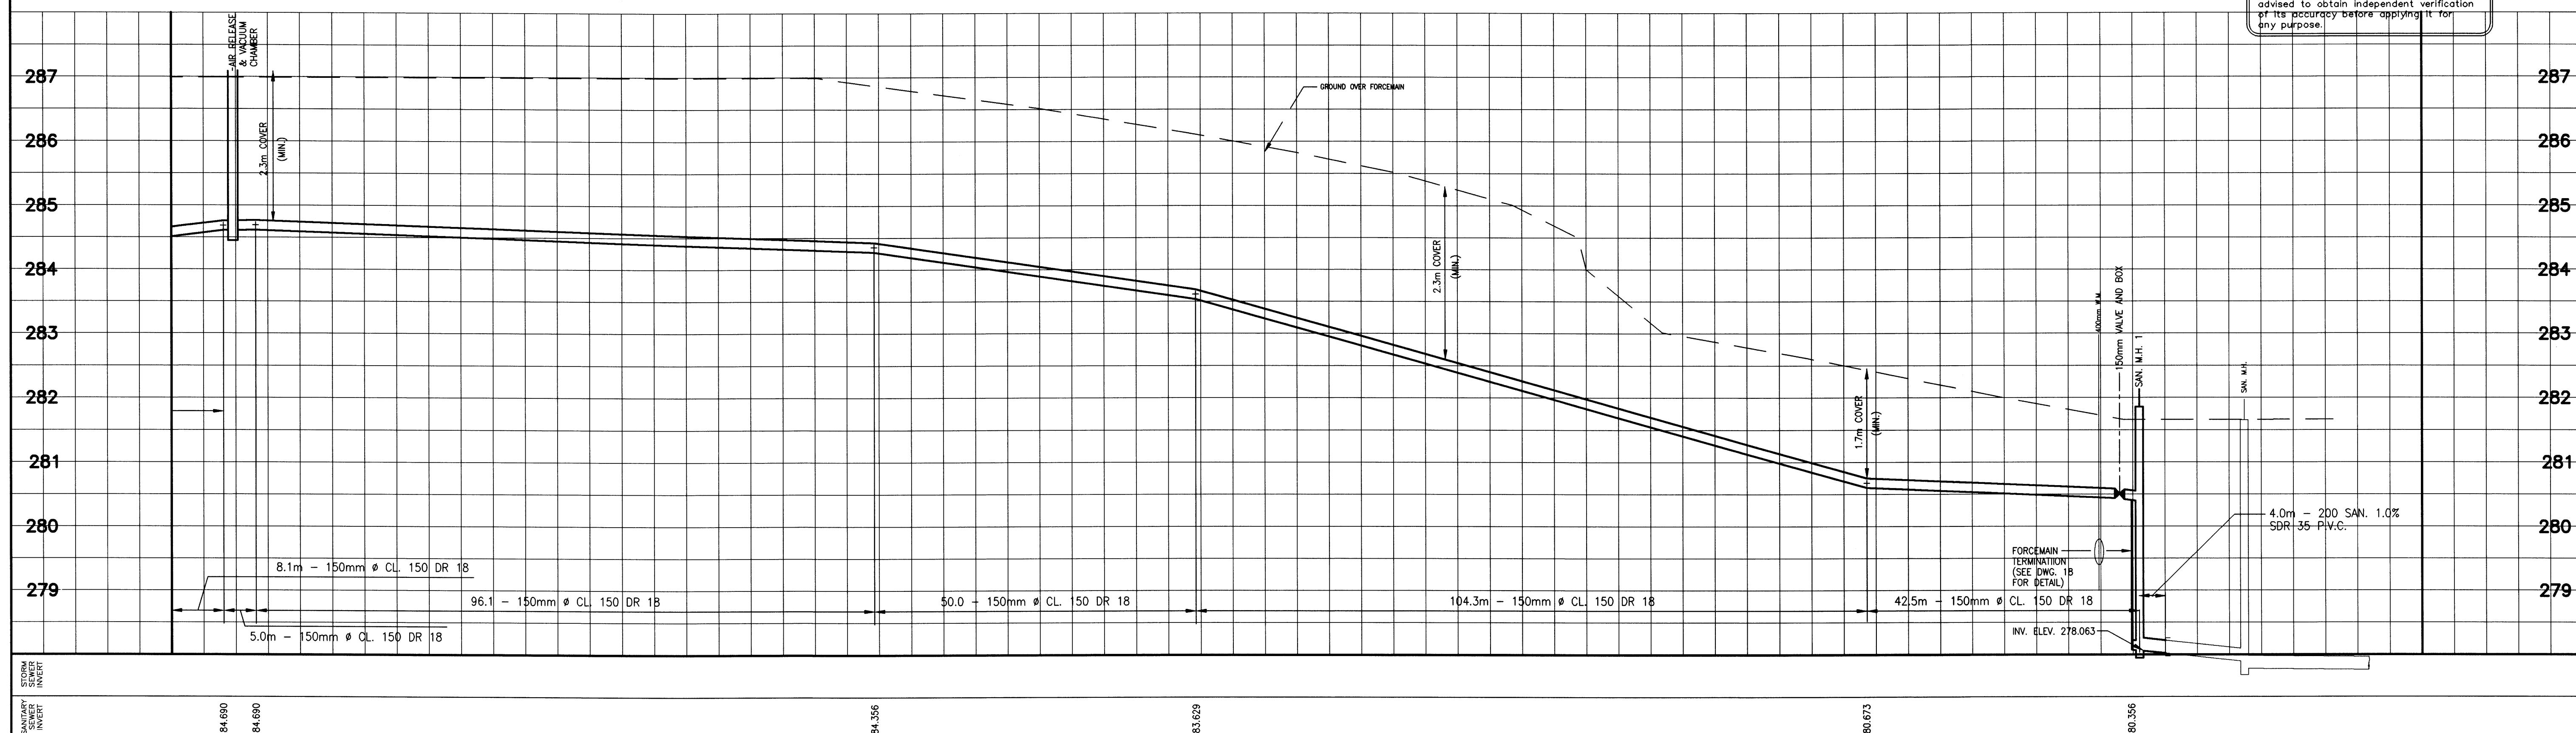10+ ARVA SANITARY SEWAGE SYSTEM

PROJECT No  
**00-7278**

**FORCEMAIN  
FROM 300m NORTH OF PLANE TREE DRIVE  
TO PLANE TREE DRIVE**




### LEGEND

- GRADE ELEVATION
- GROUND CONTOUR
- TREE
- 150mm ♂ SANITARY FORCEMAIN
- 200mm ♂ SAN. - 0.42% SAN. MH# 36 (DROP)
- SANITARY SEWER & MANHOLE
- CHAINLINK FENCE

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AS CONSTRUCTED NOTES	AS CONSTRUCTED SERVICES	COMPLETION	No	REVISIONS	DATE	BY
1	DESIGN WAB	1	AS CONSTRUCTED		NOV/01	WAB
2	DRAWN PAK					
3	CHECKED WAB					
4	APPROVED WAB					
5	DATE APRIL/2000					

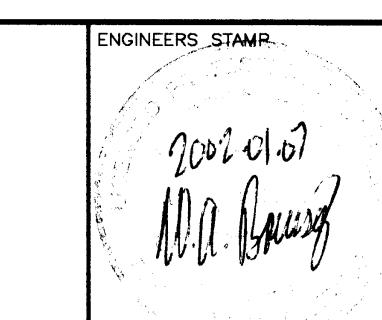


**TOWNSHIP  
OF  
MIDDLESEX  
CENTRE**

**ARVA SANITARY SEWAGE PLAN**  
**PUMPING STATION**  
**SITE LAYOUT & GENERAL ARRANGEMENT**

PROJECT No  
**00-7278**

SHEET No  
**18**

PLAN FILE No

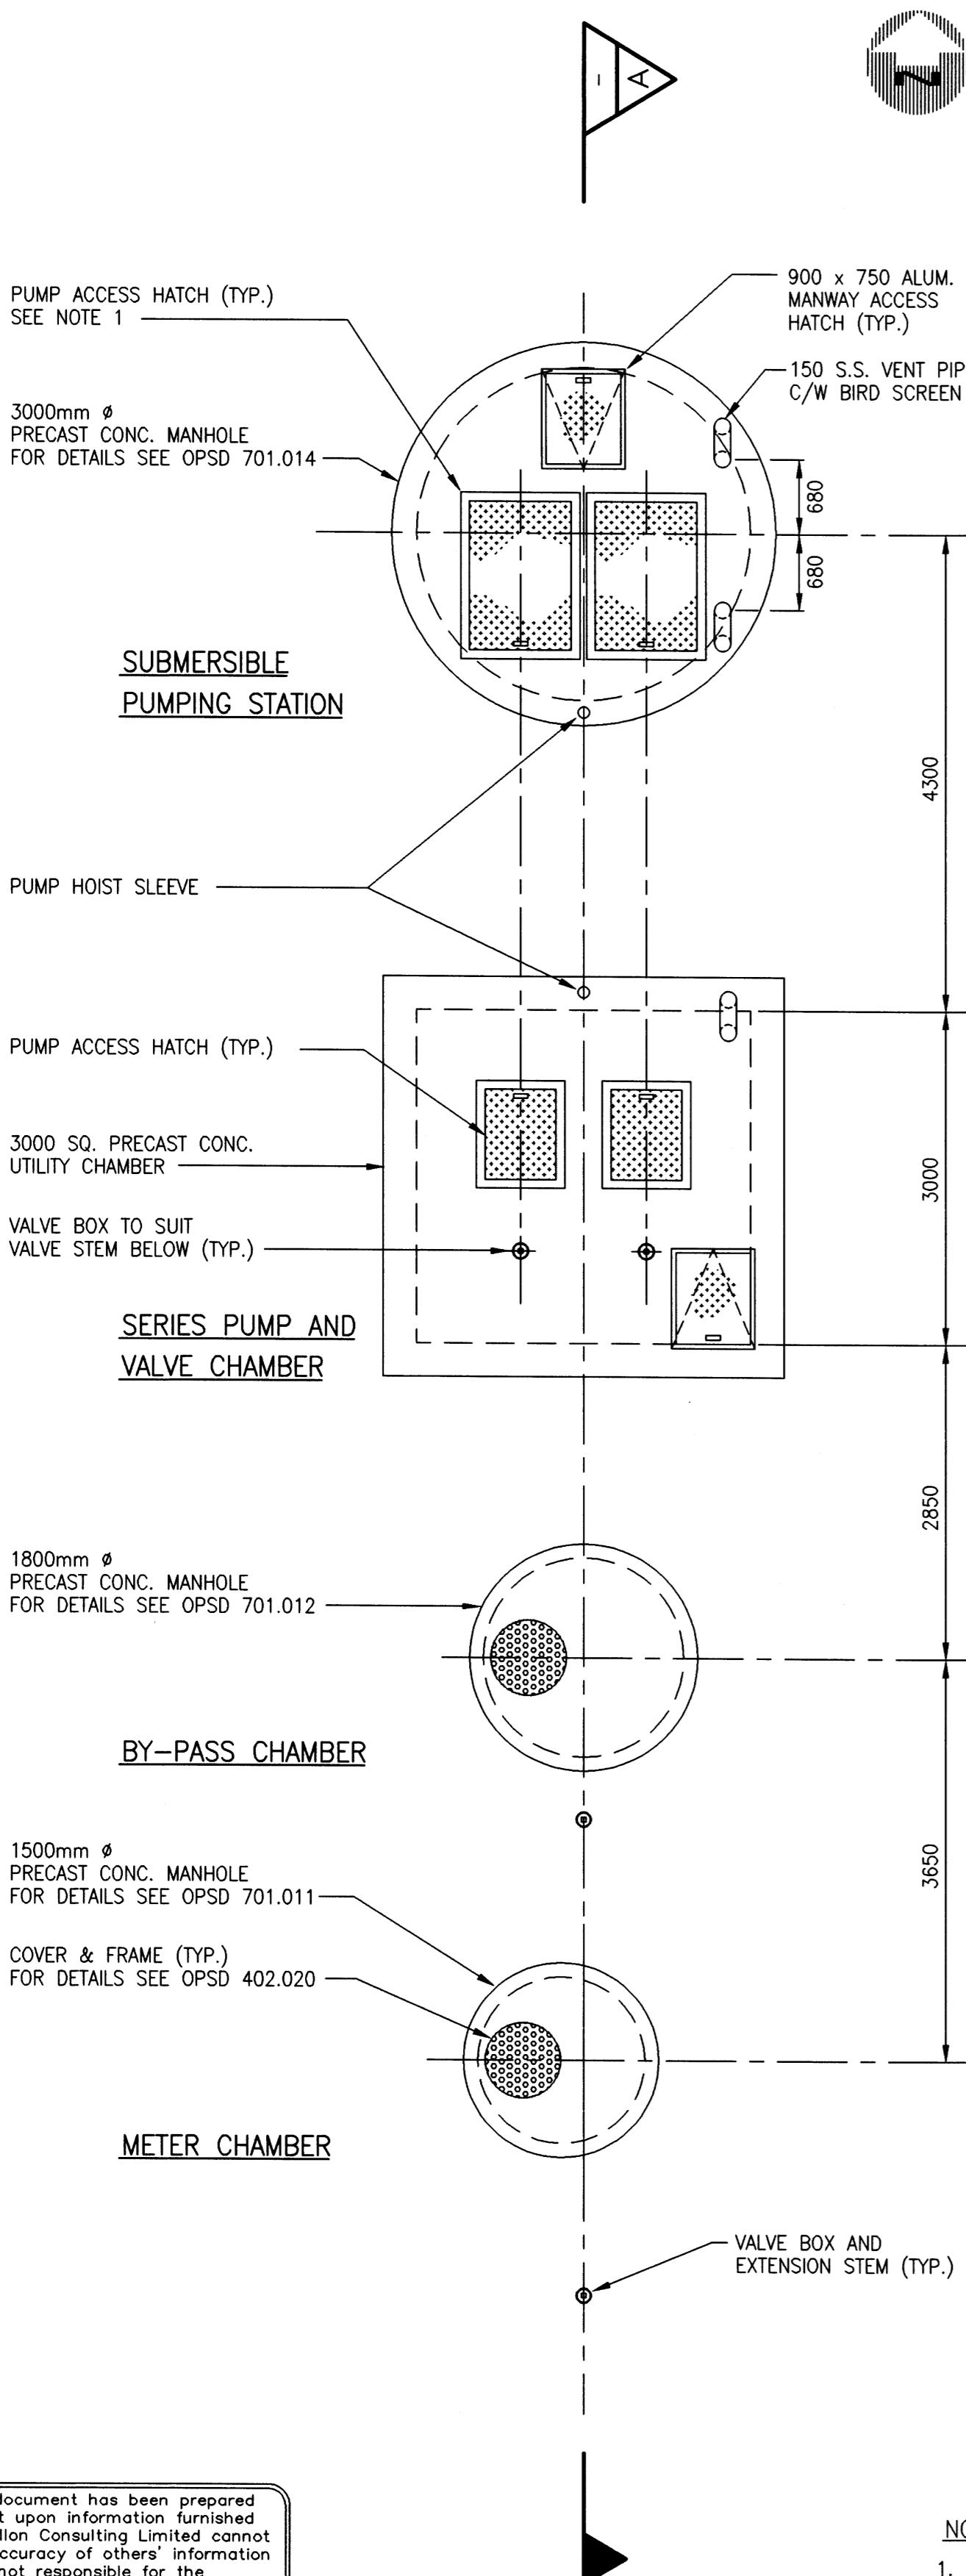


**NOTES:**

- PUMP SETTING AND HATCHES ARE TO PERMIT FUTURE INSTALLATION OF C3300 FLYGT PUMPS IN THE WET WELL.
- ALL CHAMBER BASES TO BE FOUND ON NATURAL UNDISTURBED SOIL WITH AN ALLOWABLE BEARING CAPACITY OF 200 kPa.

#### PLAN AT GRADE LEVEL

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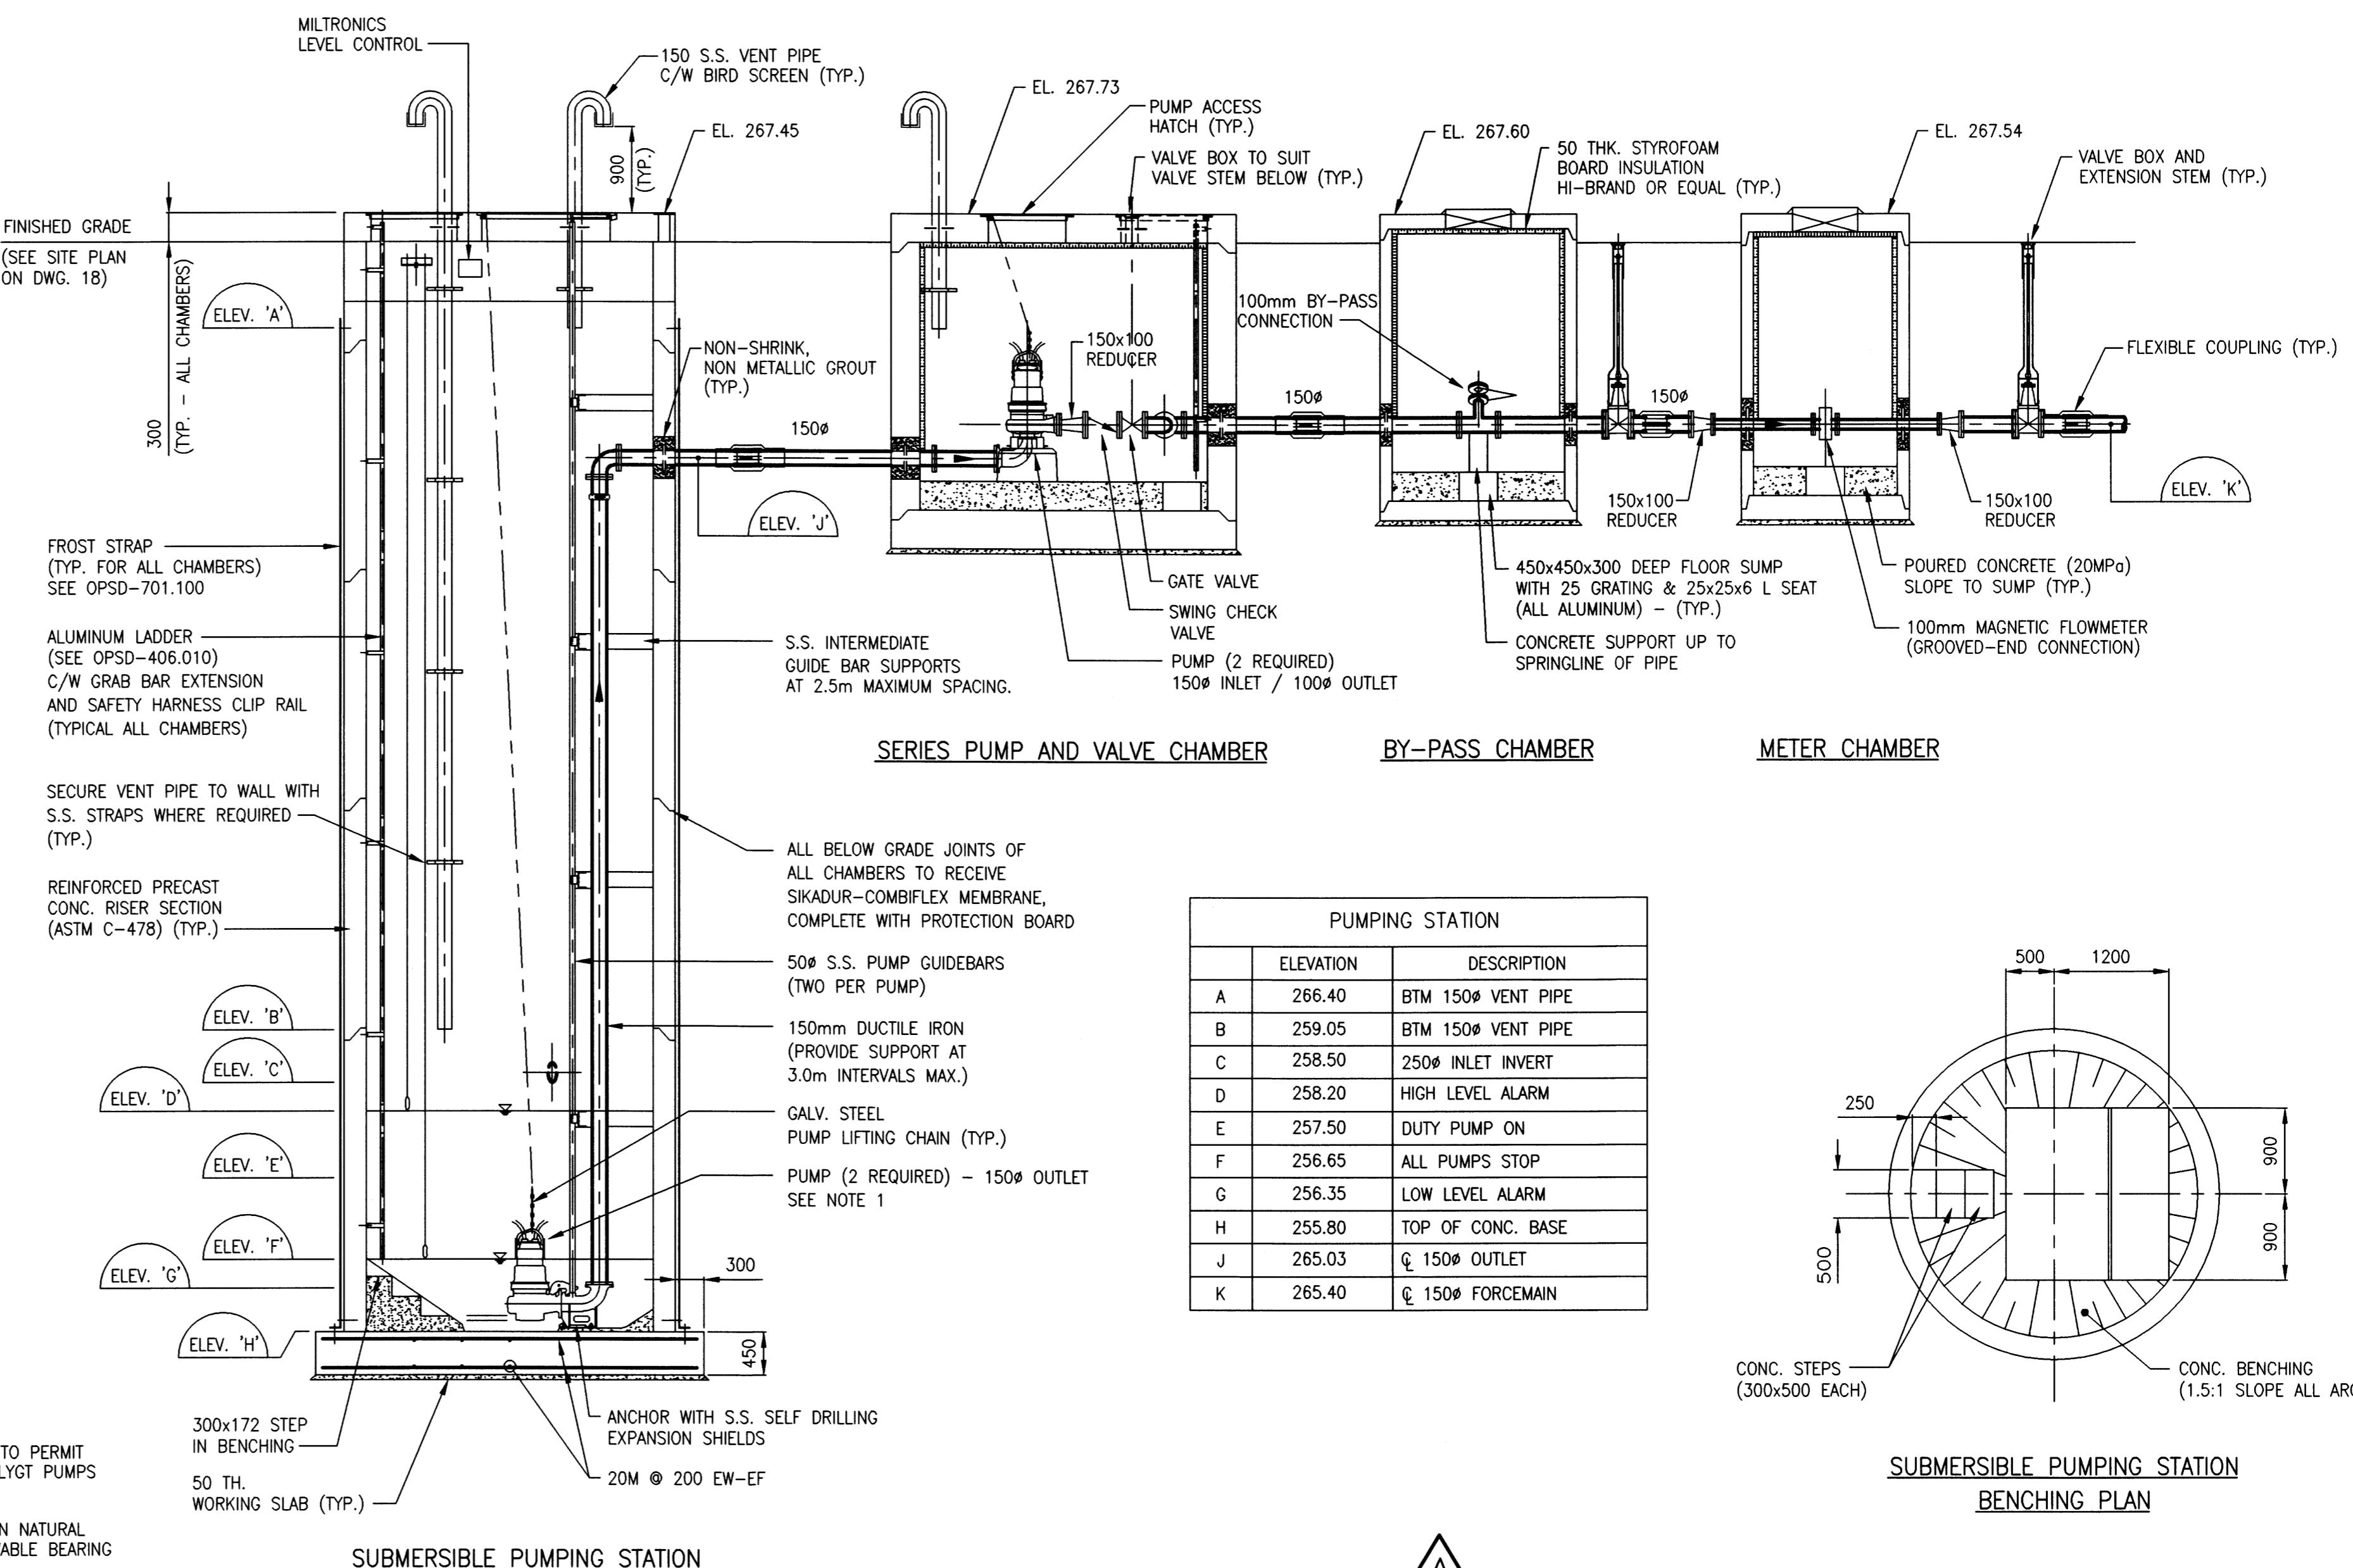
SUBMERSIBLE PUMPING STATION

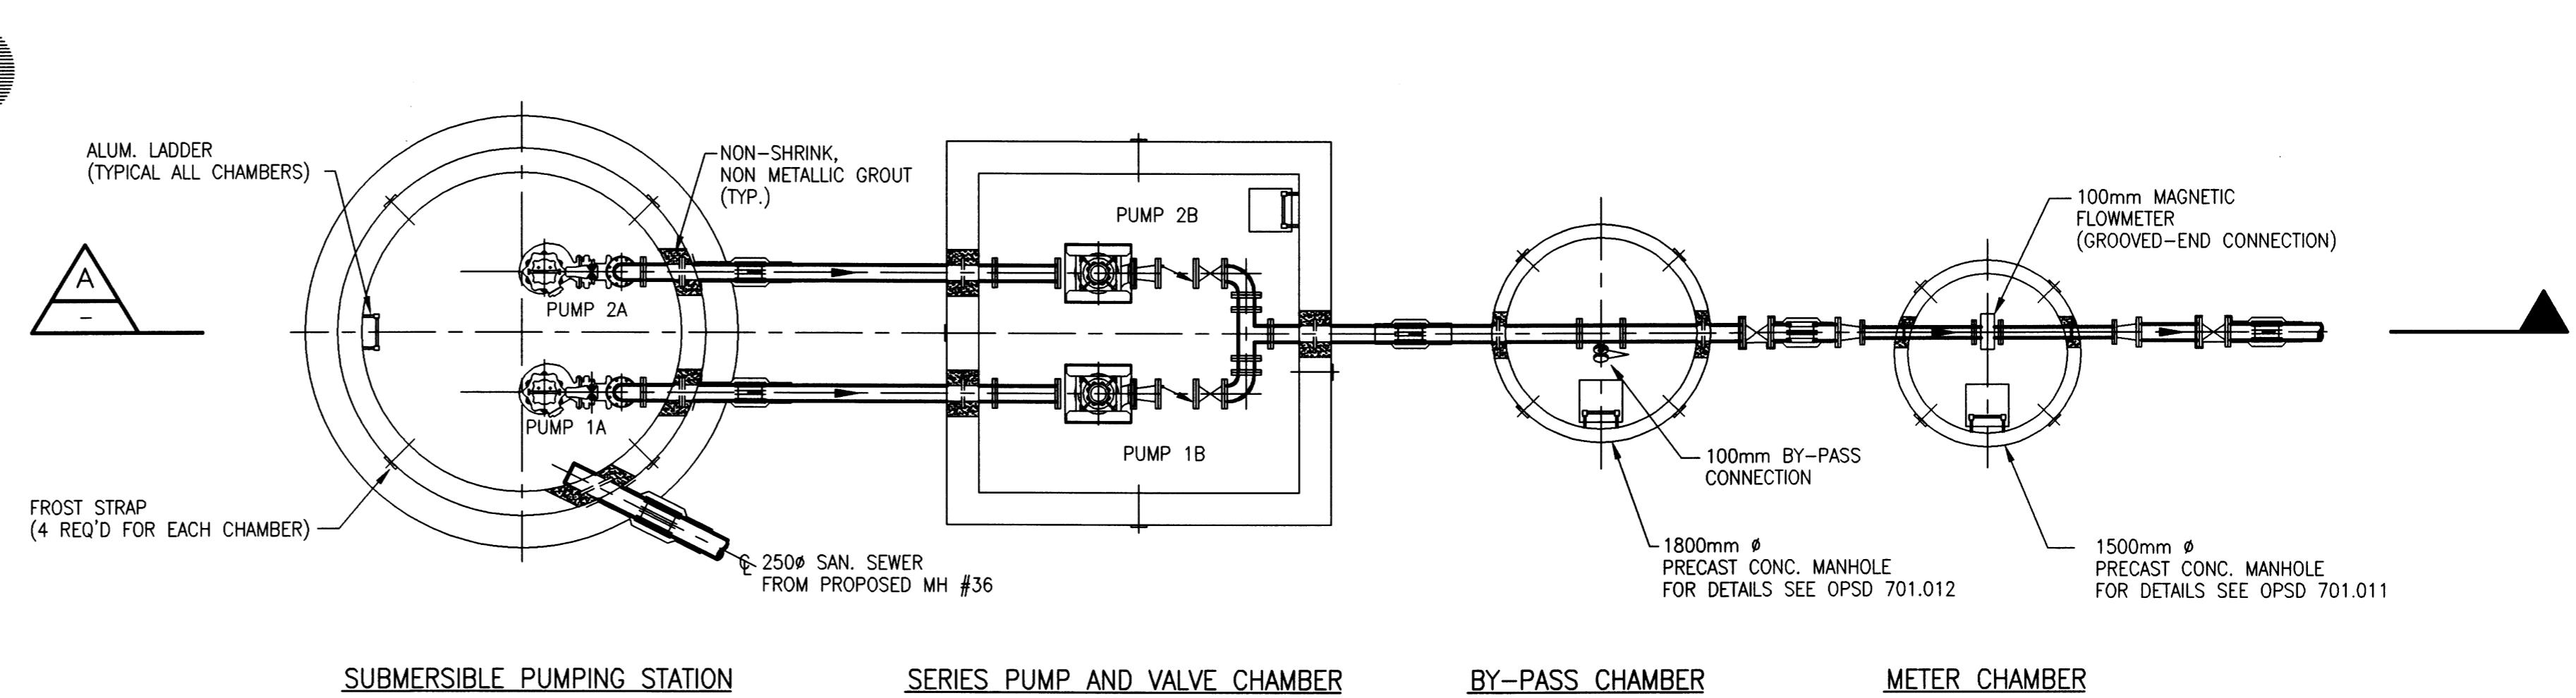SERIES PUMP AND VALVE CHAMBER


BY-PASS CHAMBER

METER CHAMBER

#### PLAN




PUMPING STATION		
	ELEVATION	DESCRIPTION
A	266.40	BTM 150Ø VENT PIPE
B	259.05	BTM 150Ø VENT PIPE
C	258.50	250Ø INLET INVERT
D	258.20	HIGH LEVEL ALARM
E	257.50	DUTY PUMP ON
F	256.65	ALL PUMPS STOP
G	256.35	LOW LEVEL ALARM
H	255.80	TOP OF CONC. BASE
J	265.03	150Ø OUTLET
K	265.40	150Ø FORCEMAIN

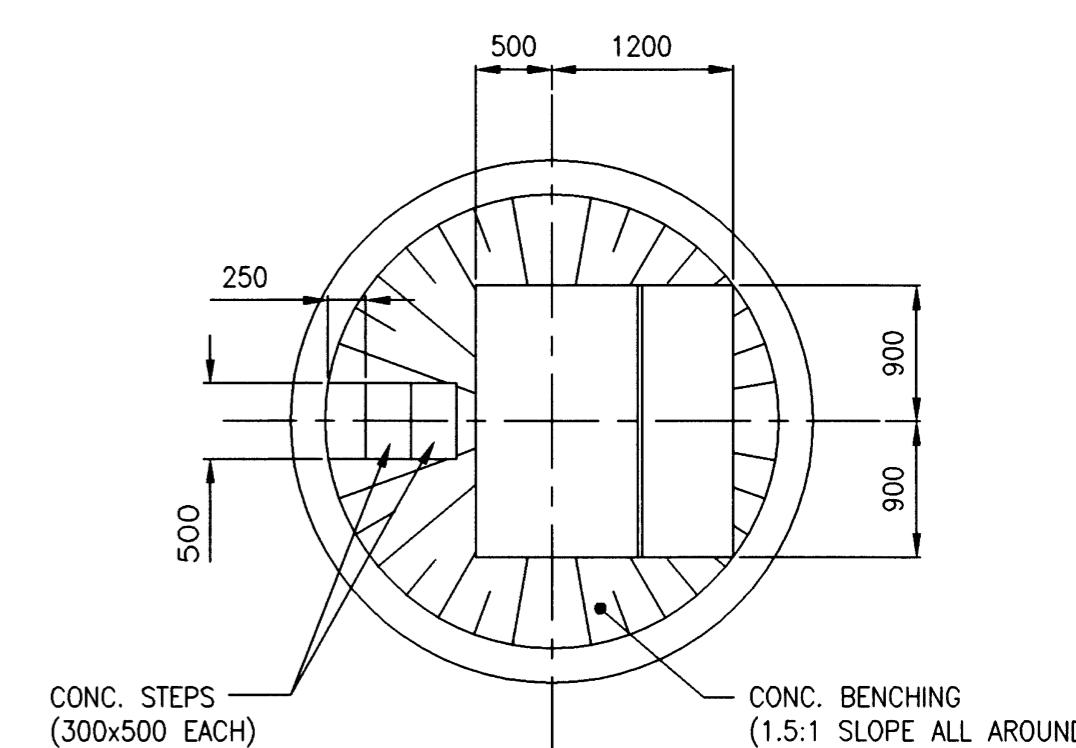

SUBMERSIBLE PUMPING STATION  
BENCHING PLAN


#### SECTION A-

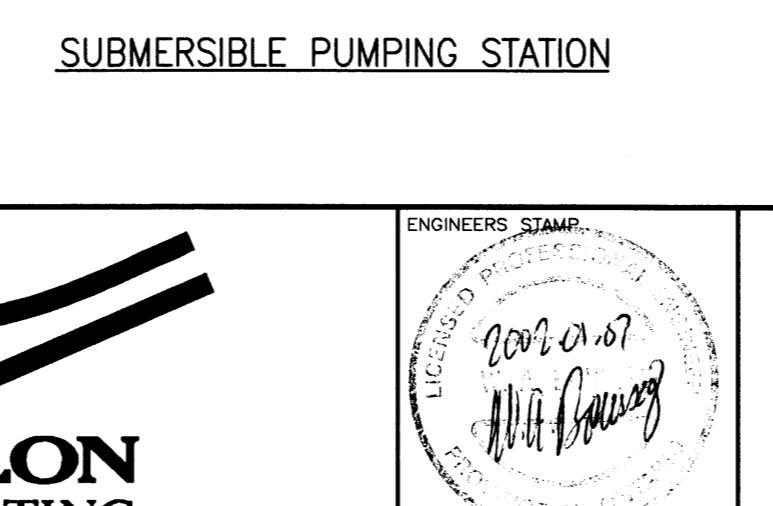

SUBMERSIBLE PUMPING STATION



TOWNSHIP  
OF  
MIDDLESEX  
CENTRE

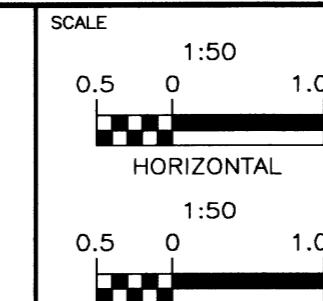


ARVA SANITARY SEWAGE SYSTEM  
PUMPING STATION  
PLANS AND SECTIONS


PROJECT No  
00-7278  
SHEET No  
19  
PLAN FILE No

AS CONSTRUCTED NOTES	AS CONSTRUCTED SERVICES	COMPLETION	No.	REVISIONS	DATE	BY
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2		DRAWN JC				
3		CHECKED GOH				
4		APPROVED WAB				
5		DATE APRIL/2000				


**DILLON**  
CONSULTING

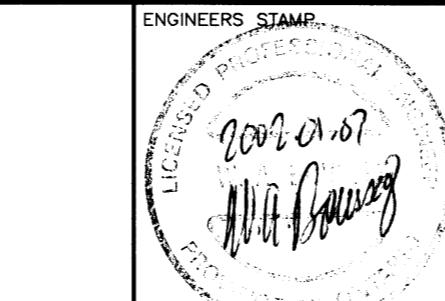

## PROOF LINE ROAD - (KING'S HIGHWAY NO. 4)

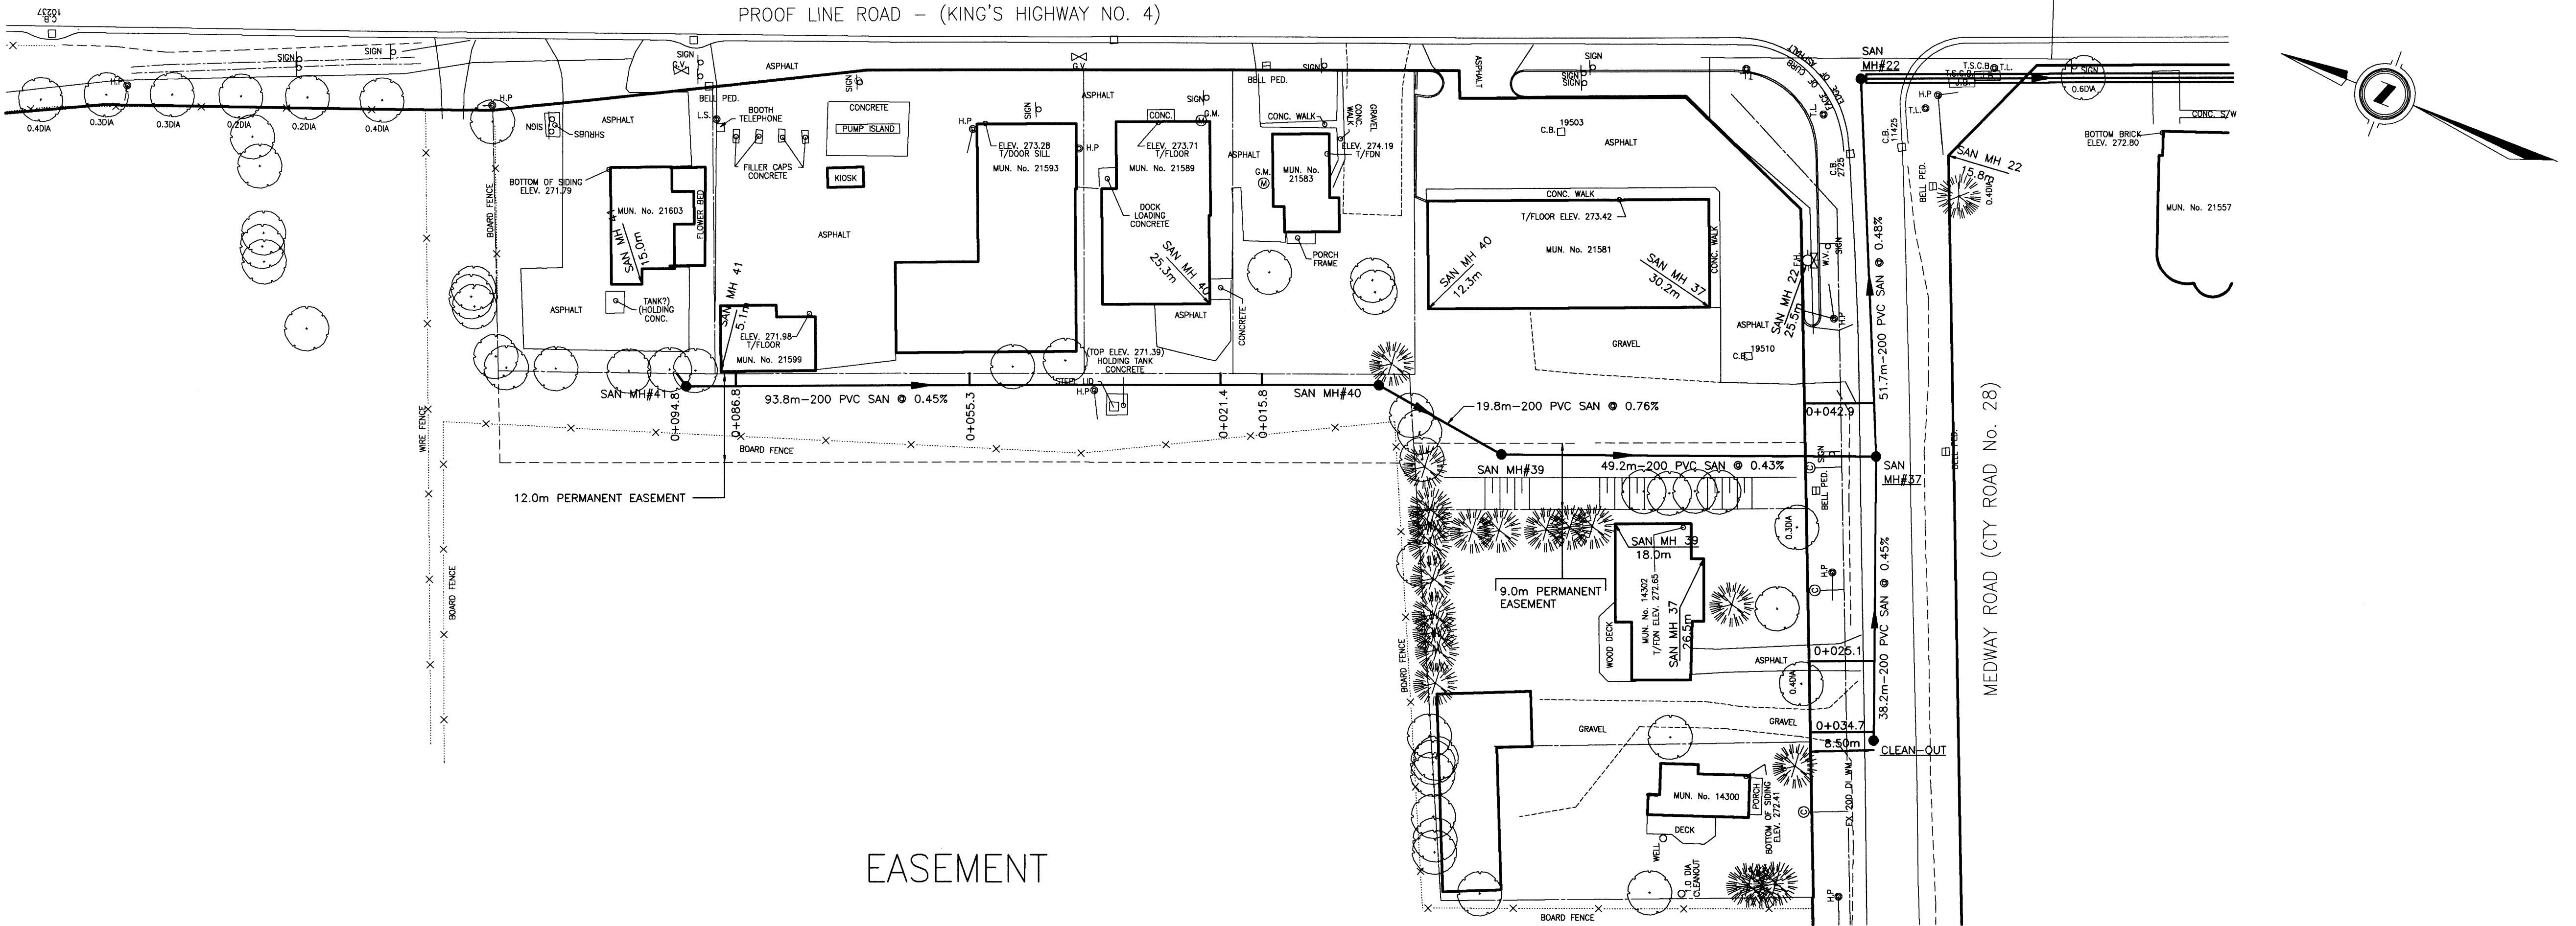

## EASEMENT

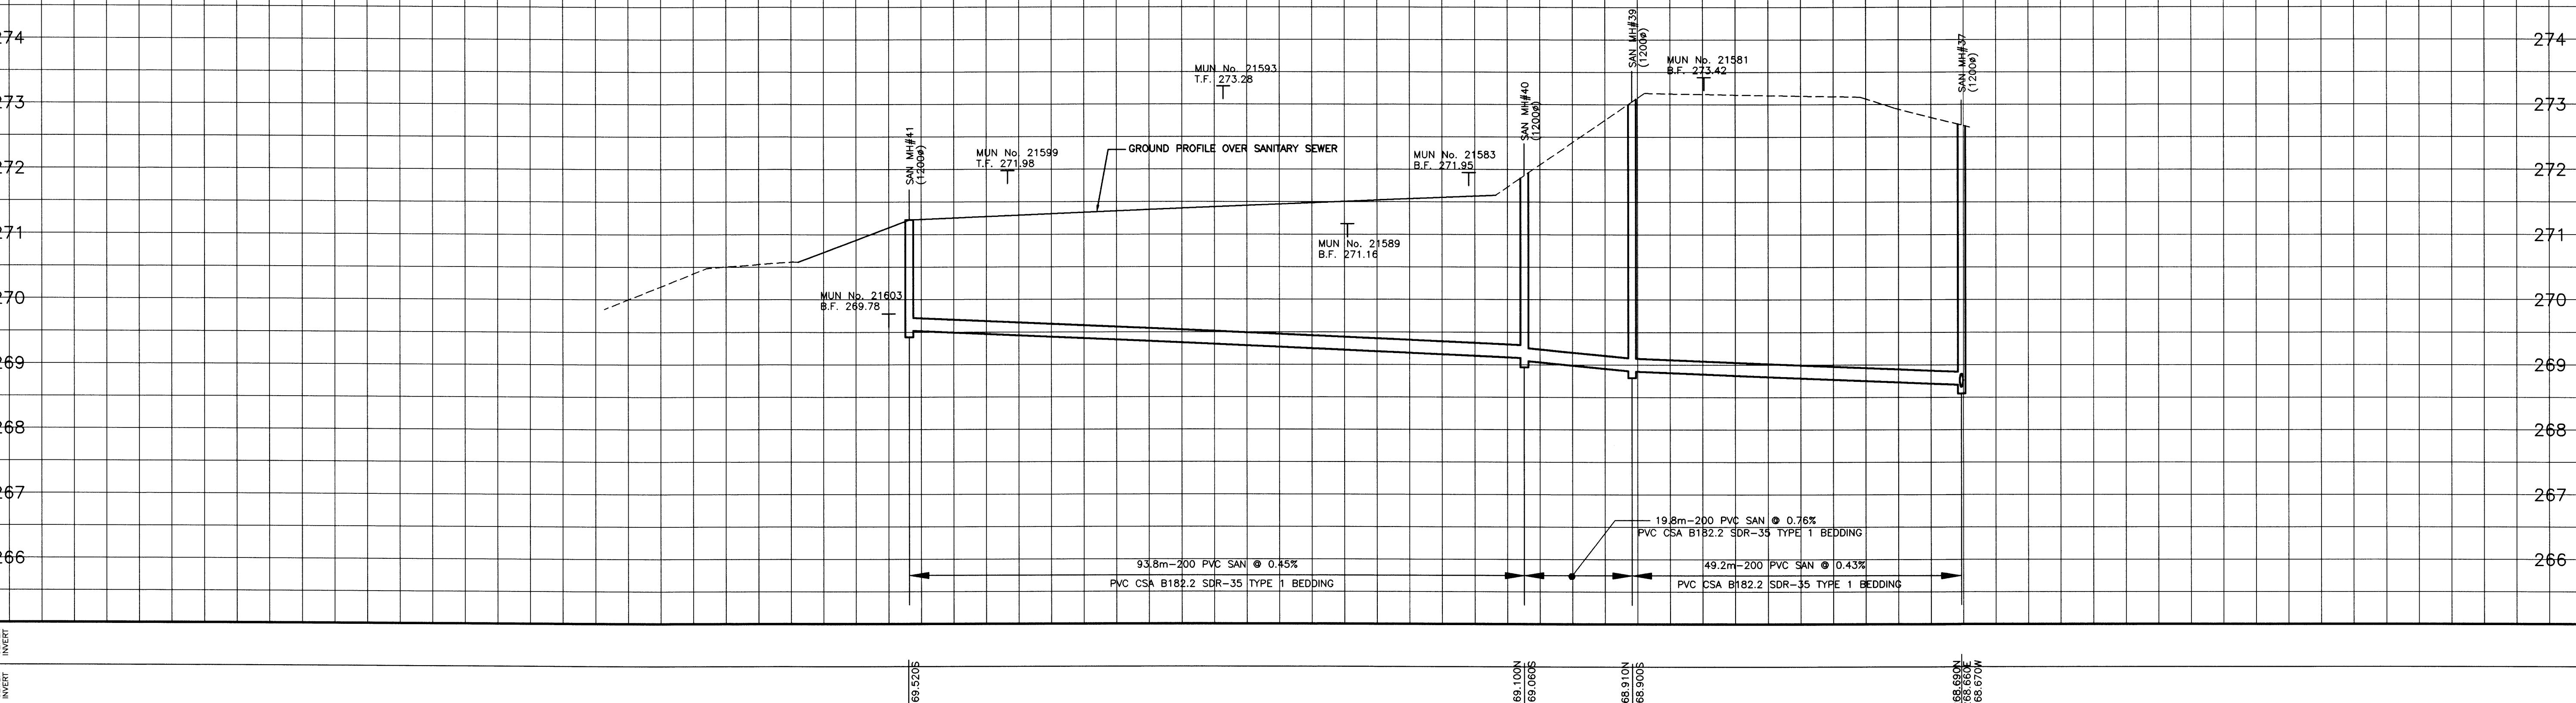

STATION

C/E 266 SANITARY SEWER INVERT

ELEV.

266.570

INVERT

266.570

STATION

C/E 274 SANITARY SEWER INVERT

ELEV.

274.000

INVERT

274.000

STATION

C/E 267 SANITARY SEWER INVERT

ELEV.

267.000

INVERT

267.000

STATION

C/E 268 SANITARY SEWER INVERT

ELEV.

268.000

INVERT

268.000

STATION

C/E 269 SANITARY SEWER INVERT

ELEV.

269.000

INVERT

269.000

STATION

C/E 270 SANITARY SEWER INVERT

ELEV.

270.000

INVERT

270.000

STATION

C/E 271 SANITARY SEWER INVERT

ELEV.

271.000

INVERT

271.000

STATION

C/E 272 SANITARY SEWER INVERT

ELEV.

272.000

INVERT

272.000

STATION

C/E 273 SANITARY SEWER INVERT

ELEV.

273.000

INVERT

273.000

STATION

C/E 274 SANITARY SEWER INVERT

ELEV.

274.000

INVERT

274.000

STATION

C/E 266 SANITARY SEWER INVERT

ELEV.

266.000

INVERT

266.000

STATION

C/E 267 SANITARY SEWER INVERT

ELEV.

267.000

INVERT

267.000

STATION

C/E 268 SANITARY SEWER INVERT

ELEV.

268.000

INVERT

268.000

STATION

C/E 269 SANITARY SEWER INVERT

ELEV.

269.000

INVERT

269.000

STATION

C/E 270 SANITARY SEWER INVERT

ELEV.

270.000

INVERT

270.000

STATION

C/E 271 SANITARY SEWER INVERT

ELEV.

271.000

INVERT

271.000

STATION

C/E 272 SANITARY SEWER INVERT

ELEV.

272.000

INVERT

272.000

STATION

C/E 273 SANITARY SEWER INVERT

ELEV.

273.000

INVERT

273.000

STATION

C/E 274 SANITARY SEWER INVERT

ELEV.

274.000

INVERT

274.000

STATION

C/E 266 SANITARY SEWER INVERT

ELEV.

266.000

INVERT

266.000

STATION

C/E 267 SANITARY SEWER INVERT

ELEV.

267.000

INVERT

267.000

STATION

C/E 268 SANITARY SEWER INVERT

ELEV.

268.000

INVERT

268.000

STATION

C/E 269 SANITARY SEWER INVERT

ELEV.

269.000

INVERT

269.000

STATION

C/E 270 SANITARY SEWER INVERT

ELEV.

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INVERT

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STATION

C/E 271 SANITARY SEWER INVERT

ELEV.

271.000

INVERT

271.000

STATION

C/E 272 SANITARY SEWER INVERT

ELEV.

272.000

INVERT

272.000

STATION

C/E 273 SANITARY SEWER INVERT

ELEV.

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INVERT

273.000

STATION

C/E 274 SANITARY SEWER INVERT

ELEV.

274.000

INVERT

274.000

STATION

C/E 266 SANITARY SEWER INVERT

ELEV.

266.000

INVERT

266.000

STATION

C/E 267 SANITARY SEWER INVERT

ELEV.

267.000

INVERT

267.000

STATION

C/E 268 SANITARY SEWER INVERT

ELEV.

268.000

INVERT

268.000

STATION

C/E 269 SANITARY SEWER INVERT

ELEV.

269.000

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STATION

C/E 270 SANITARY SEWER INVERT

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STATION

C/E 271 SANITARY SEWER INVERT

ELEV.

271.000

INVERT

271.000

STATION

C/E 272 SANITARY SEWER INVERT

ELEV.

272.000

INVERT

272.000

STATION

C/E 273 SANITARY SEWER INVERT

ELEV.

273.000

INVERT

273.000

STATION

C/E 274 SANITARY SEWER INVERT


ELEV.

274.000



INVERT

274.000




**PROOF LINE ROAD - (KING'S HIGHWAY NO. 4)**

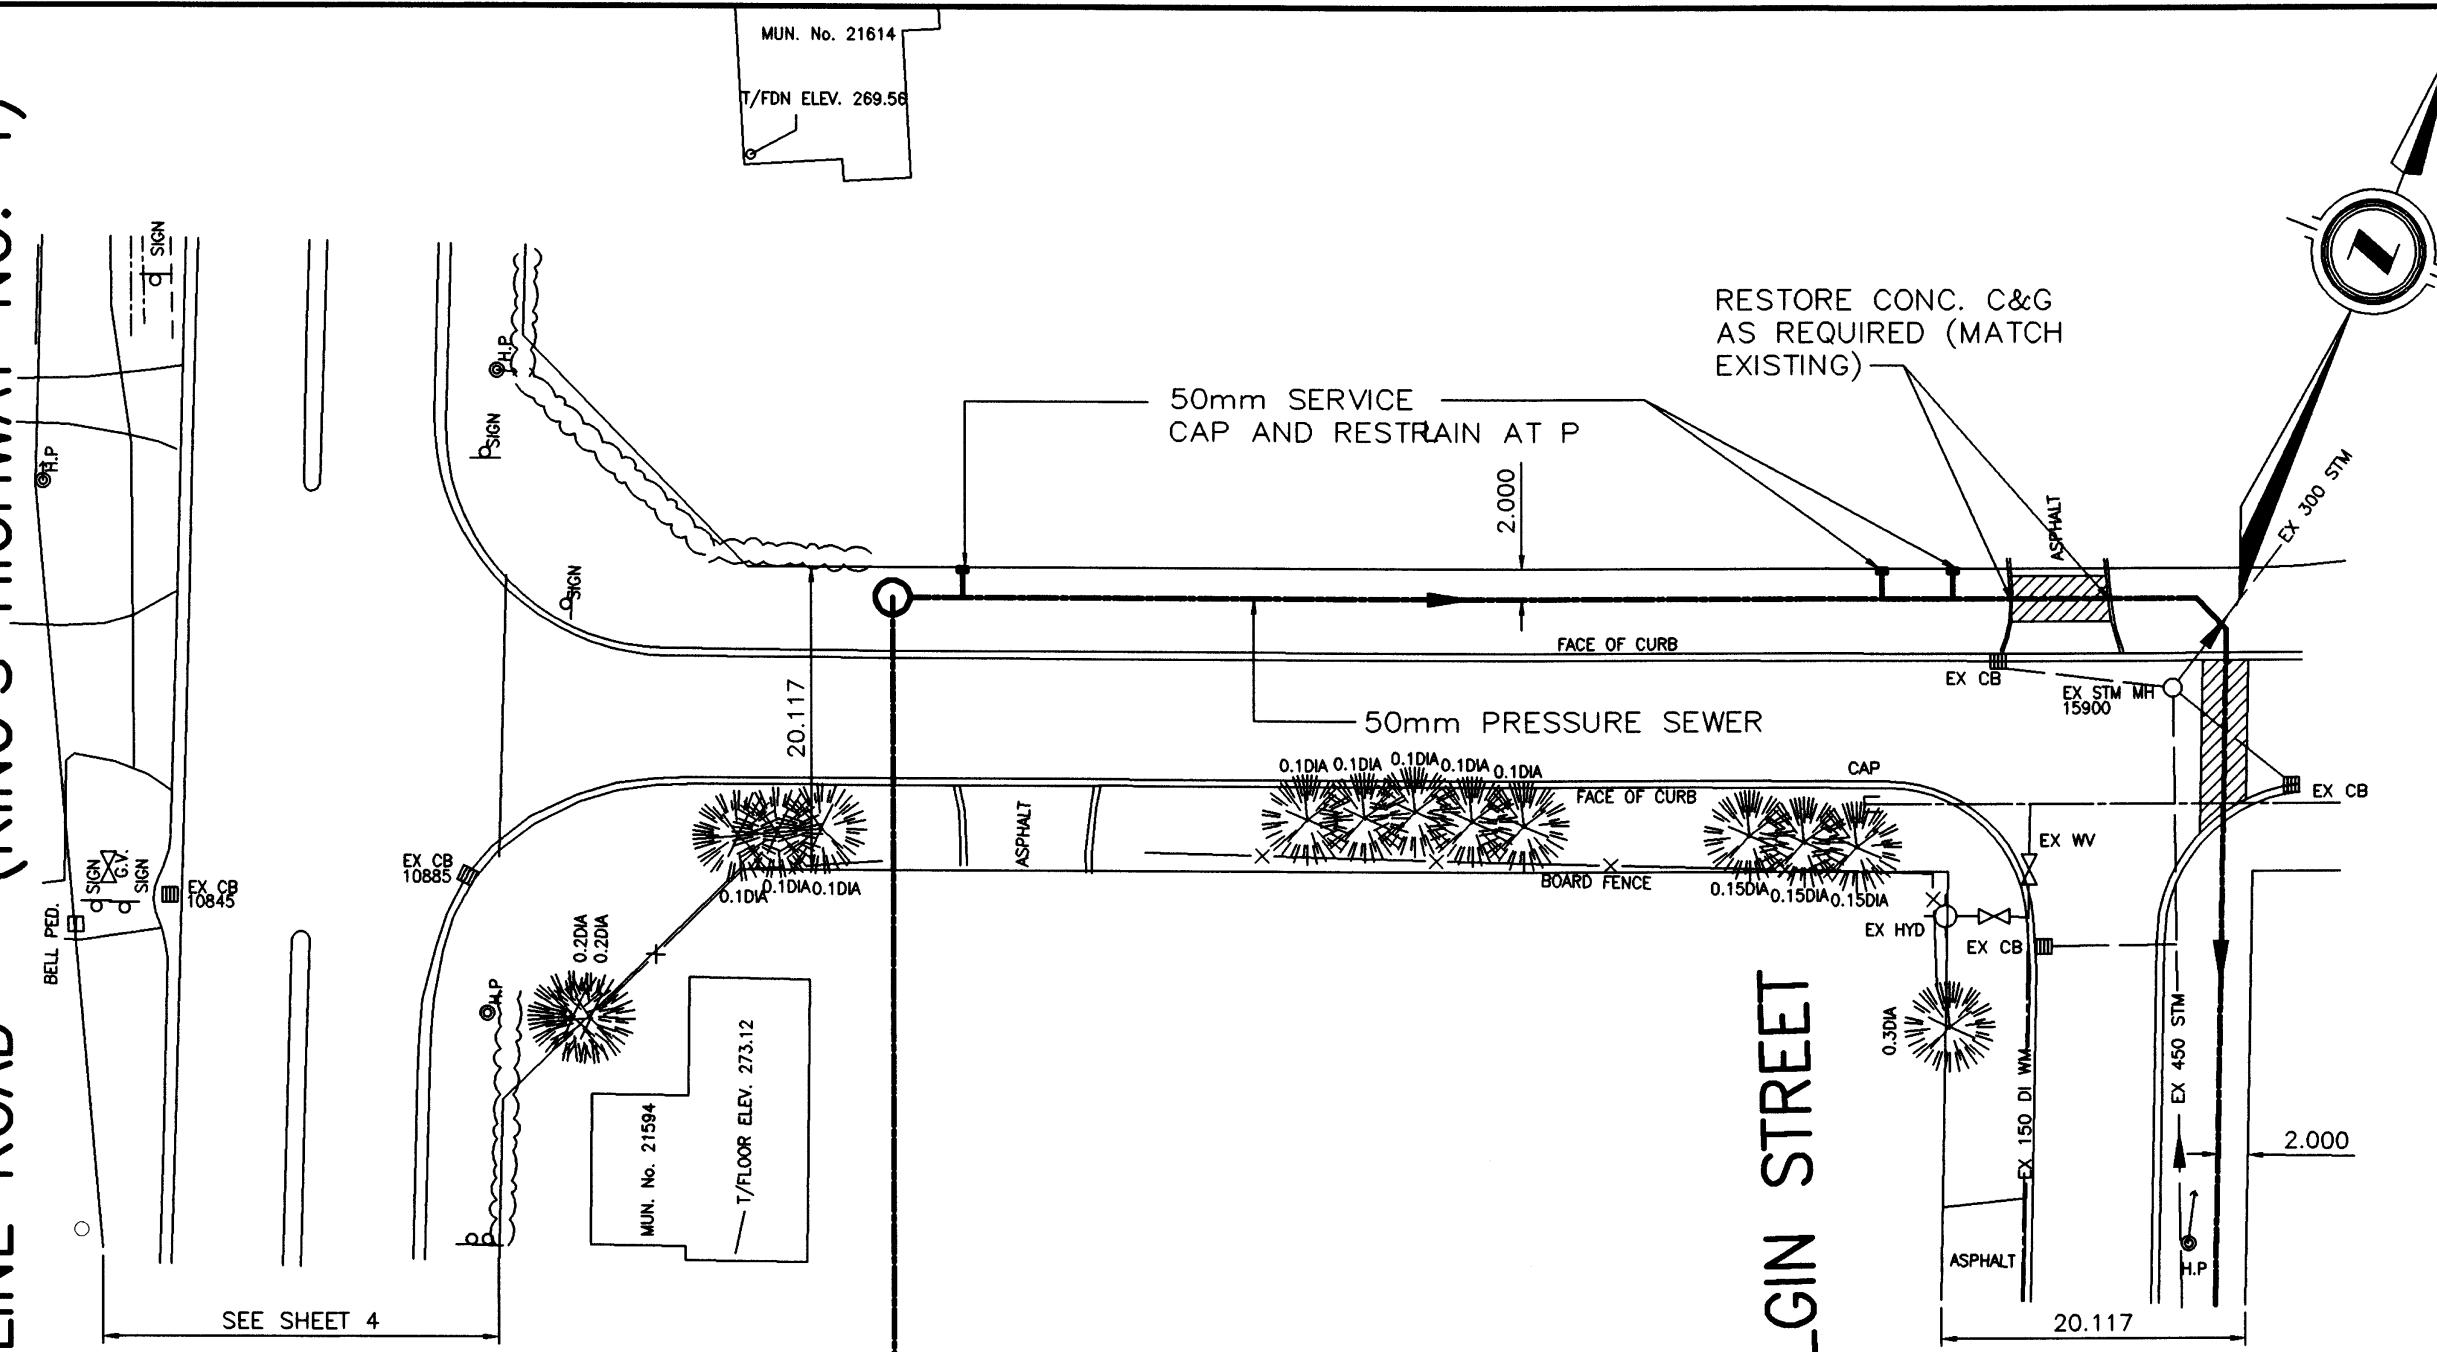

# ELGIN STREET

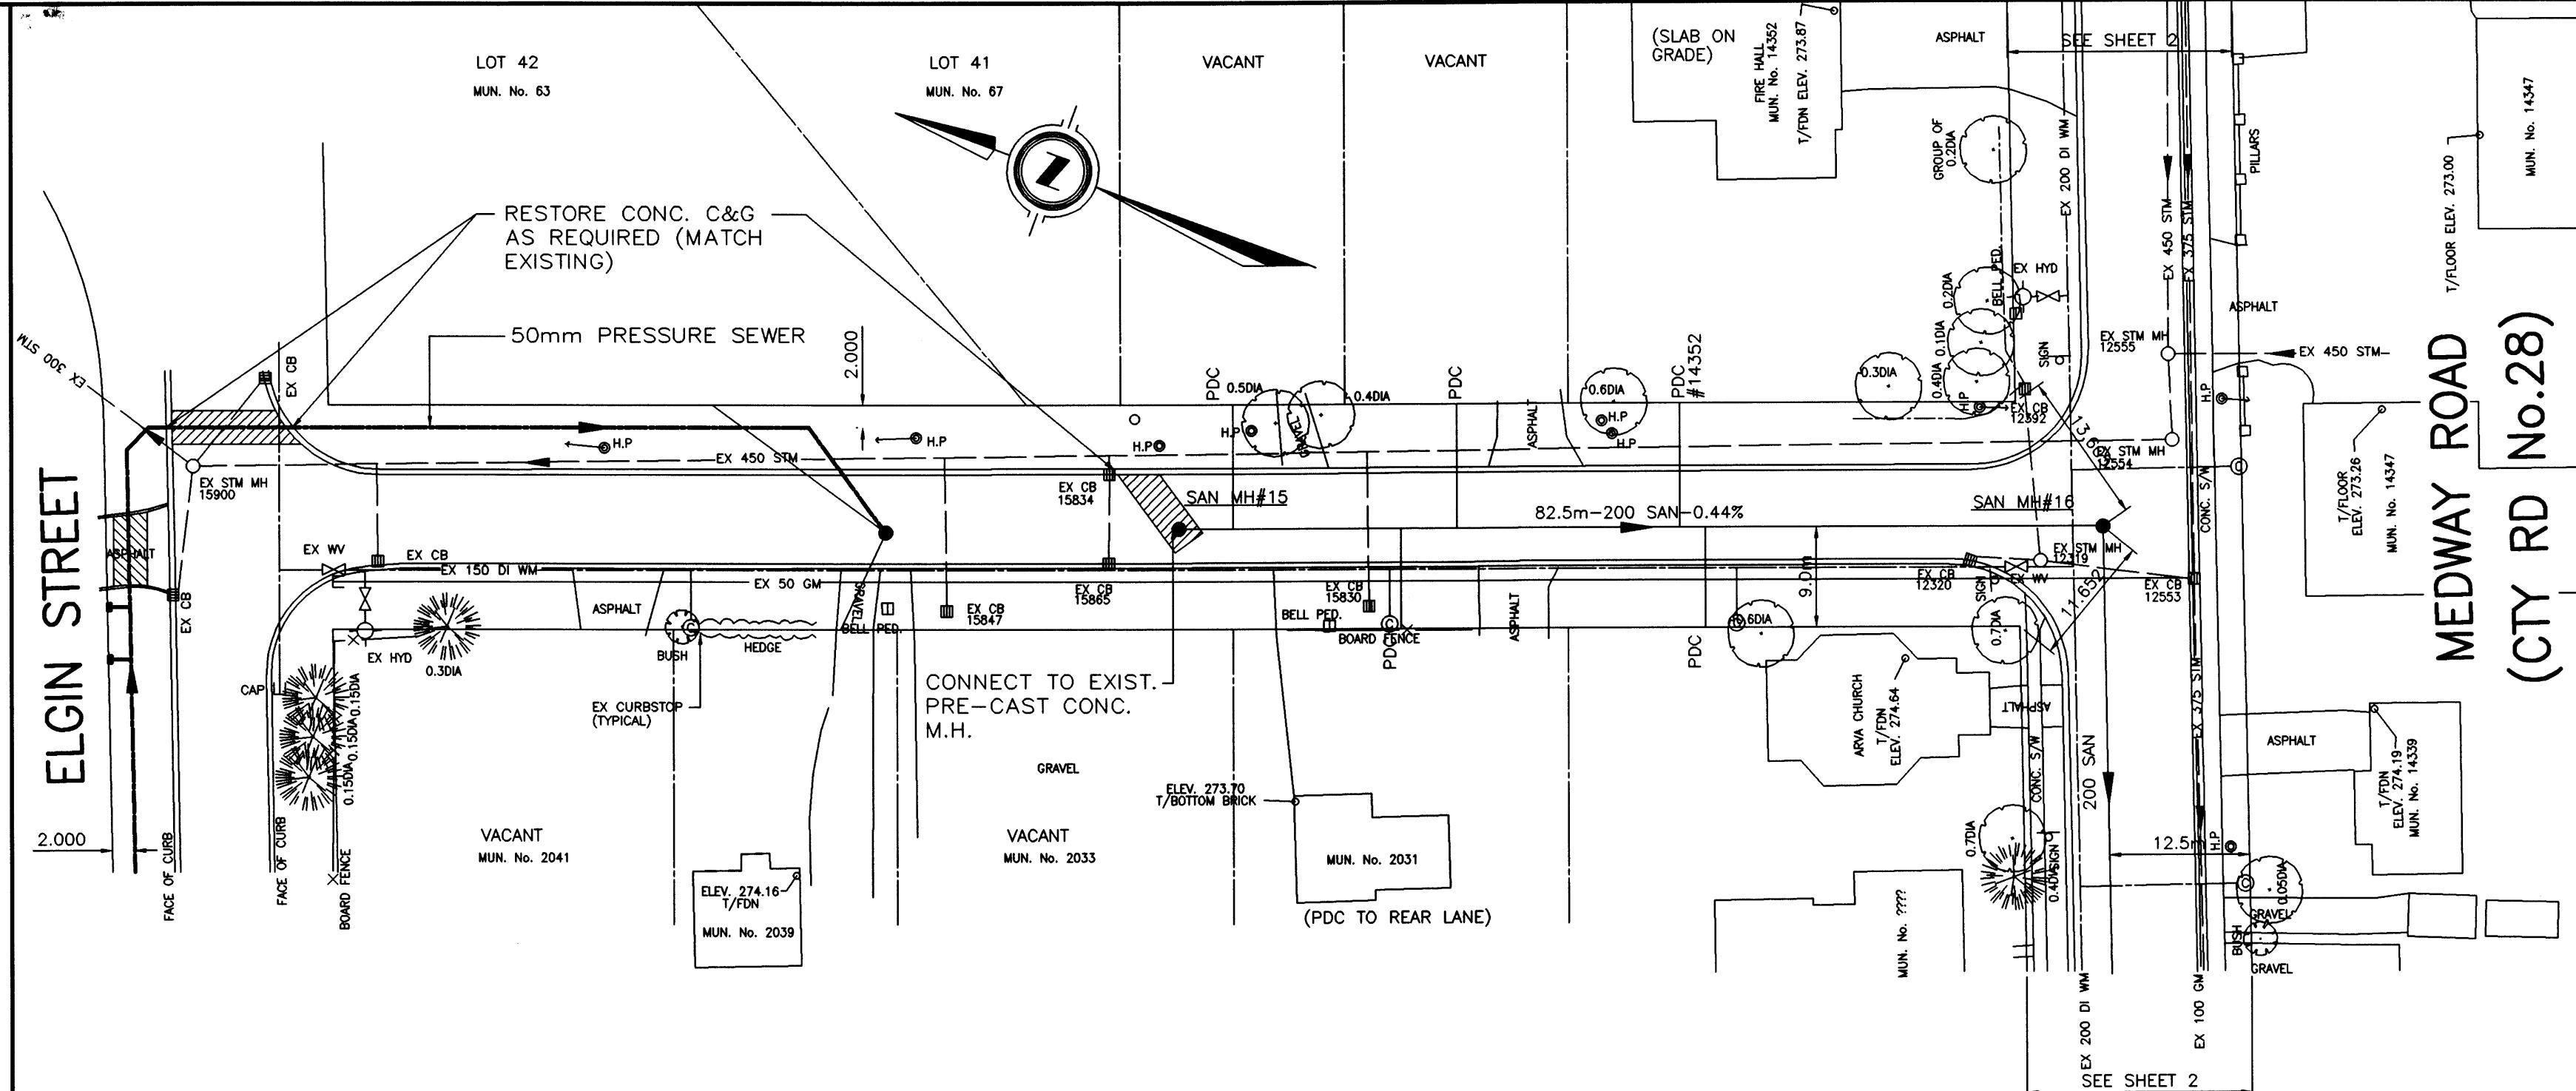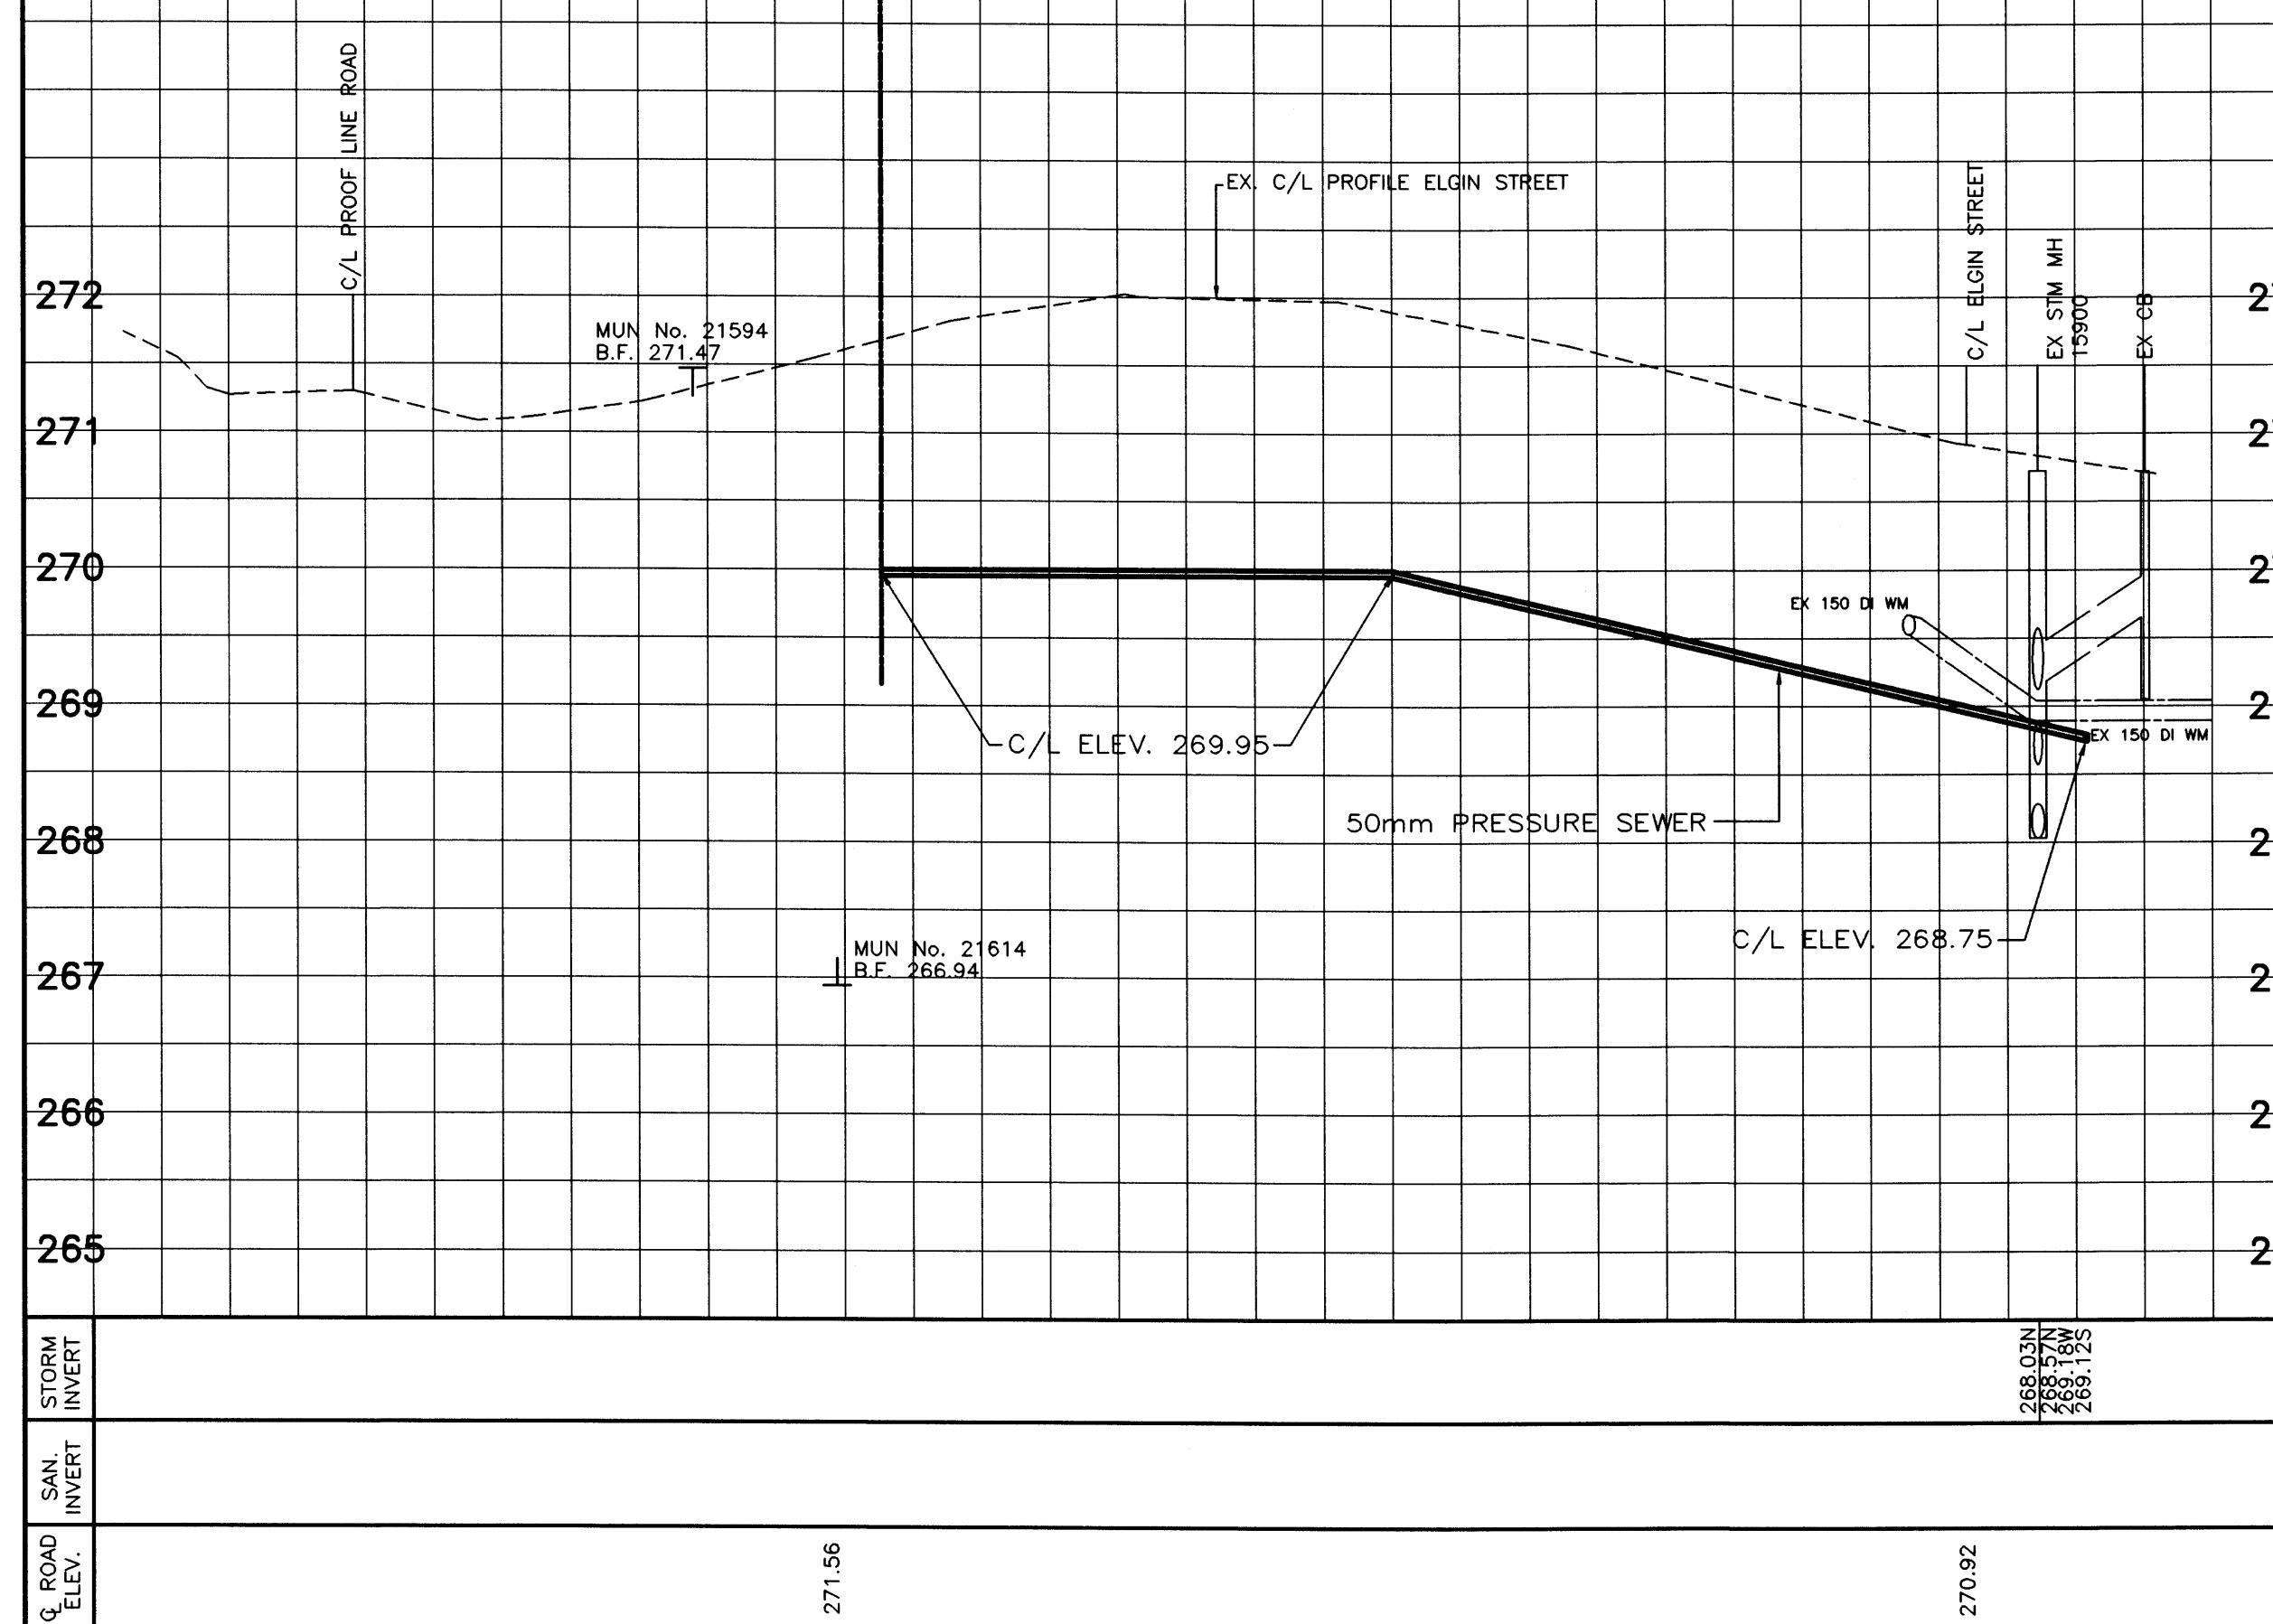

# ELGIN STREET

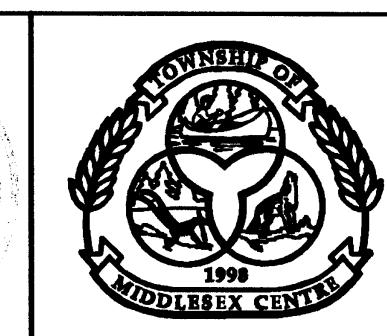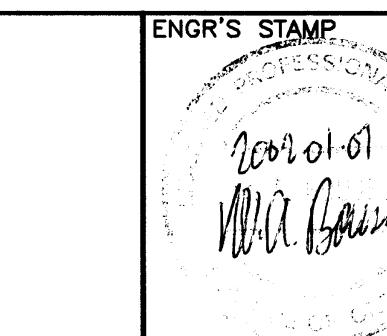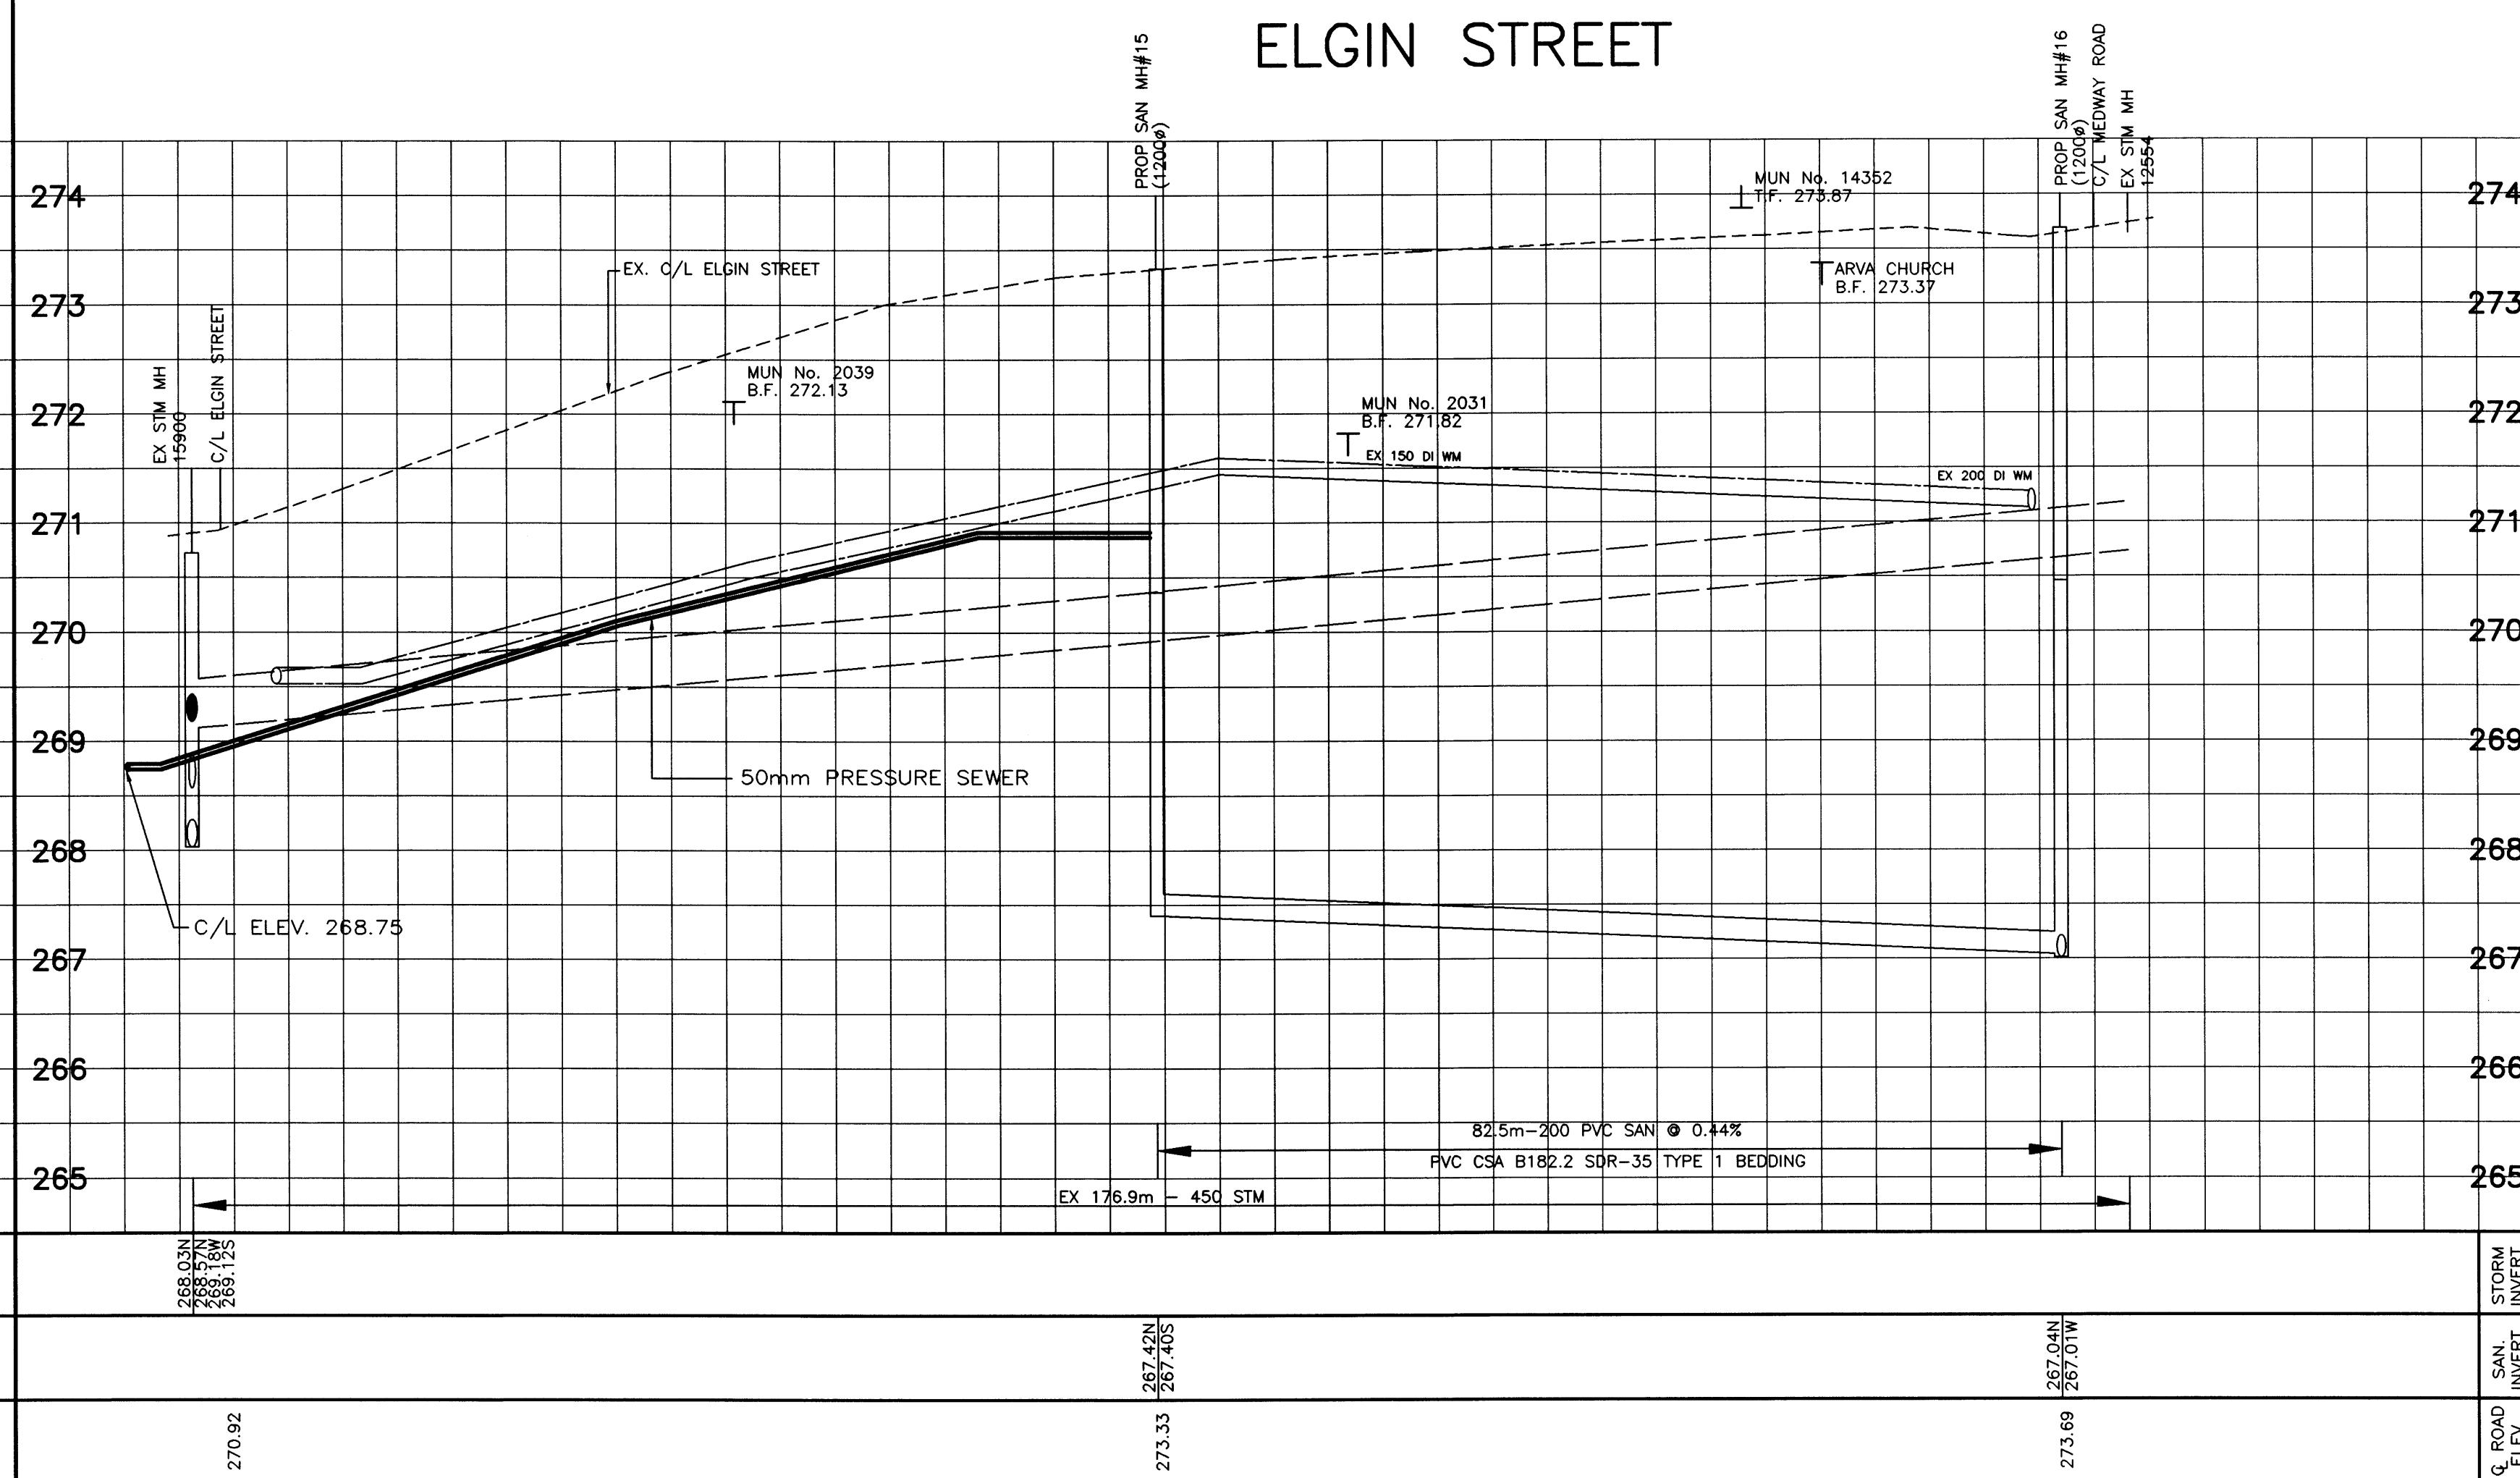

*TOWNSHIP  
OF  
MIDDLESEX  
CENTRE*

*TOWNSHIP  
OF  
MIDDLESEX  
CENTRE*

**SCALE**

HORIZONTAL - 1 : 500

5 0 10m


VERTICAL - 1 : 50

0.5 0 1m


**ARVA SANITARY SEWAGE SYSTEM**

**ELGIN STREET  
SANITARY PRESSURE SEWER**


PROJECT No  
00-7278  
SHEET No  
21  
PLAN FILE No

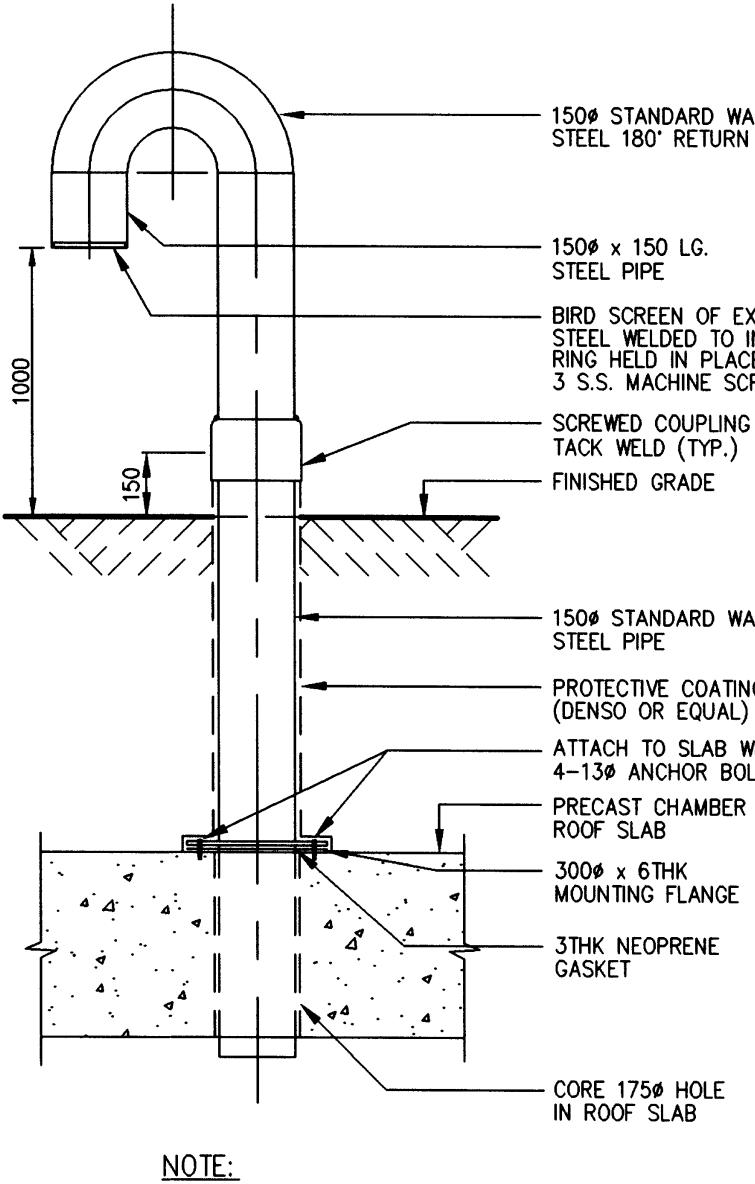

VENT DETAIL

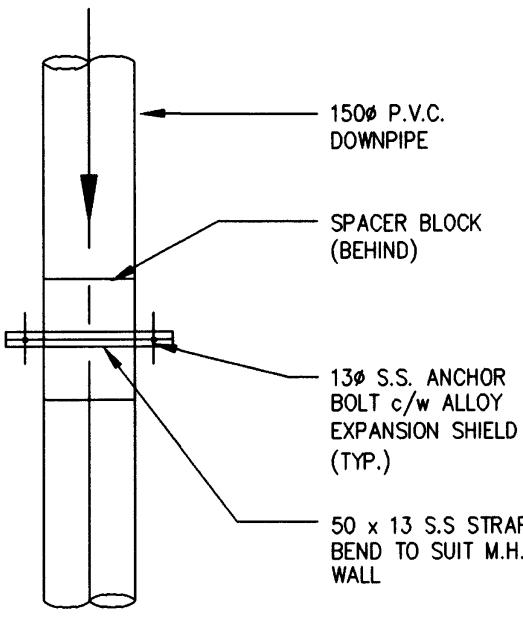


ELEVATION A-A

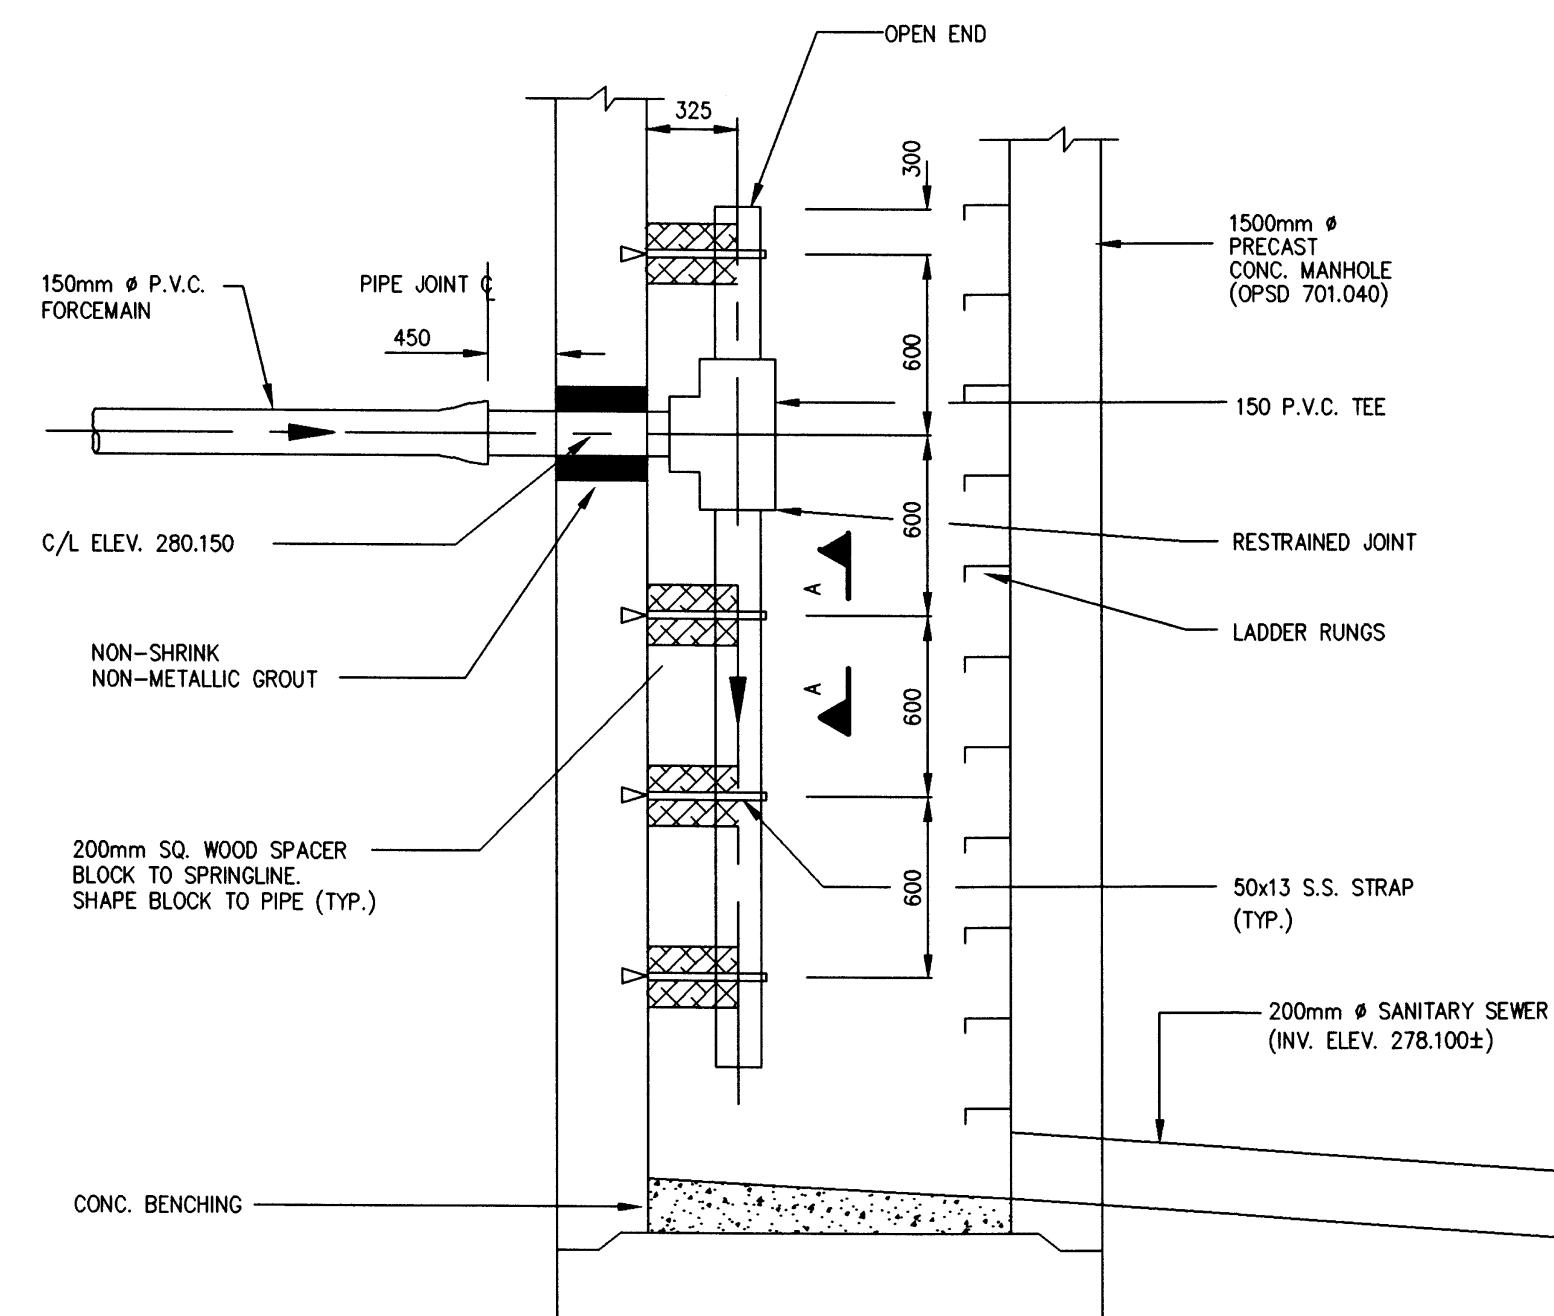


SECTION

FORCEMAIN TERMINATION DETAIL

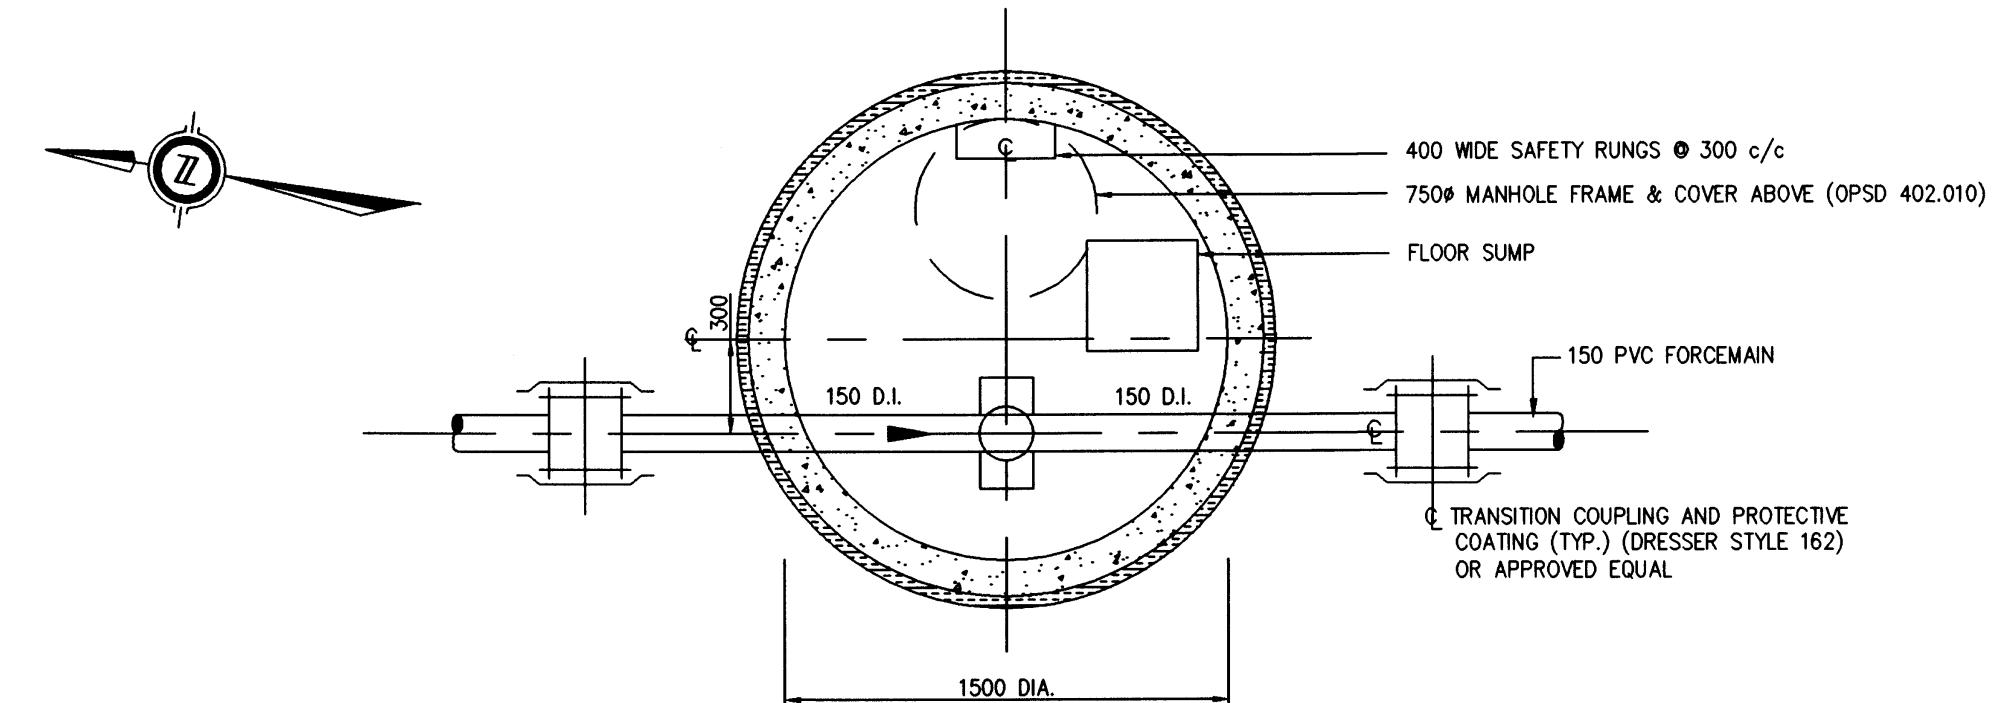

PLAN

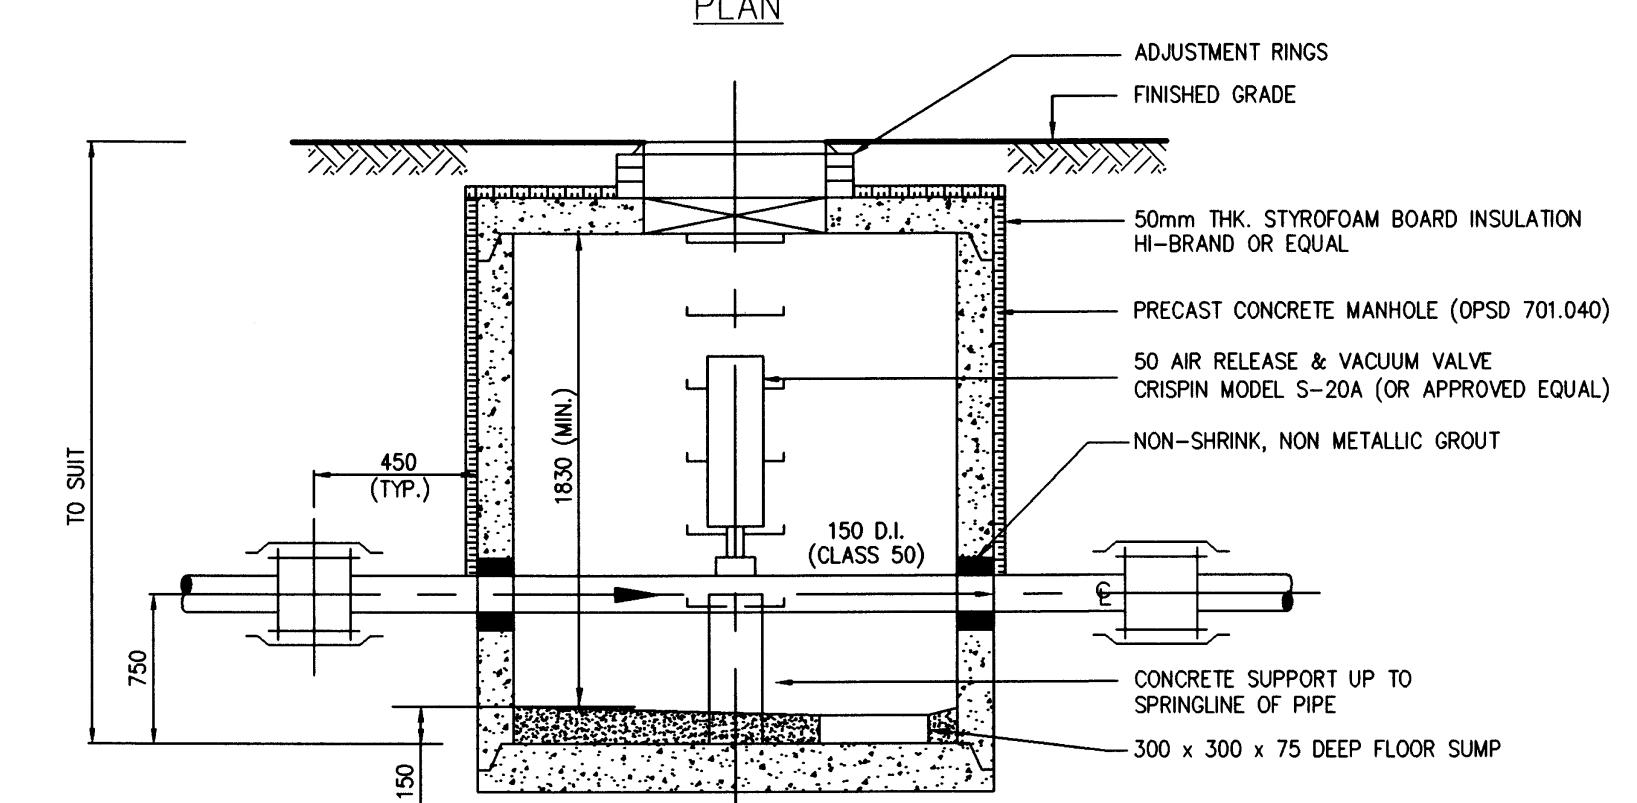


SECTION


AIR RELEASE AND VACUUM CHAMBER

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AS CONSTRUCTED NOTES			AS CONSTRUCTED SERVICES		COMPLETION		REVISIONS		DATE		BY	
1			DESIGN	PAK	1	AS CONSTRUCTED			NOV/01	WAB		
2			DRAWN	PAK								
3			CHECKED	G.O.H.								
4			APPROVED	WAB								
5			DATE	APRIL/2000								

  
DILLON  
CONSULTING

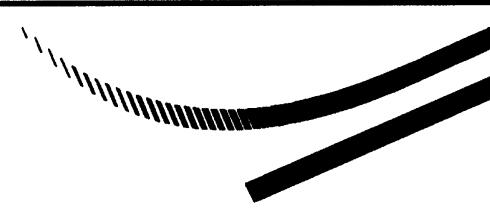ENGINEERS STAMP  
*2002/01/07*  
*M.G. Bawany*

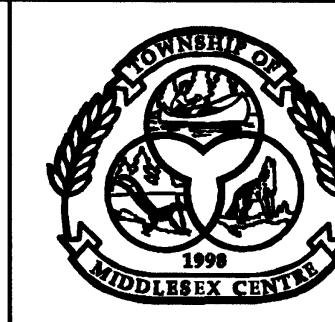

TOWNSHIP  
OF  
MIDDLESEX  
CENTRE

SCALE  
1:50  
5.0 0 10m  
HORIZONTAL  
1:50  
0.5 0 1.0m  
VERTICAL

ARVA SANITARY SEWAGE SYSTEM  
MISCELLANEOUS DETAILS ONE

PROJECT No  
00-7278  
SHEET No  
22  
PLAN FILE No

## GENERAL NOTES

All work shall be done in accordance with the minimum standards and specifications of the City of London, and The Ontario Provincial Standard Specifications.

Existing topographical information was obtained in the field by Archibald, Gray & McKay

Type II bedding shall be in accordance with OPSD 802.010 for flexible pipes. The Type II bedding and cover material shall consist of approved OPSS Form 1010 Granular 'A' material having a maximum aggregate size of 20mm.

All bedding material shall be compacted to a minimum of 95% of the material's Standard Proctor Maximum Dry Density (SPMDD).

Backfill shall be select native excavated material compacted to at least 98% Standard Proctor Maximum Dry Density (SPMDD).

All existing boulevards and road surfaces disturbed during construction shall be restored to a condition at least as good as original, all to the satisfaction of the Engineer.

All existing underground plant (hydro, telephone, gas mains, watermains, sewers) which will be crossed under during the installation of the services shall be supported by a support beam or by other methods, as may be required by the owners of the plant being crossed under.

Prior to commencement of any construction, benchmarks, elevations, and dimensions must be checked and verified, and any discrepancies reported to the Engineer.

Prior to commencing any work on the installation of services, an approved set of plans must be available on the site, and remain there while work is being done.

At least 48 hours prior to commencing construction on any existing Road Allowance maintained by the City of London, the Contractor shall obtain the necessary permits from the City, after discussion with the staff.


Prior to the commencement of construction, all existing underground utilities will be advised by the utility owner and located and marked. Any utilities damaged or disturbed during construction shall be repaired or replaced to the satisfaction of the governing body at the Contractor's expense. The Contractor is to meet all the requirements of the Owners of the Utilities on this plan and must make satisfactory arrangements with the utility companies for crossing their installations and for providing adequate protection during construction.

The Contractor shall take all necessary precautions under The Occupational Health and Safety Act while working in the vicinity of overhead power lines.

All excavation wholly or partly within proposed or existing roadways, shall be backfilled and compacted in accordance with Ontario Provincial Standard Specifications.


Existing trees damaged during construction shall be trimmed as directed. The contractor shall take precautions to minimize damage to any trees or overhanging limbs.

The Contractor is to contact London Hydro at least 3 working days prior to excavating within 1m (top of slope) of all hydro poles. The Contractor is not permitted to make support connections to London Hydro poles. London Hydro is required to attach and remove all supports from each pole and shall be compensated for all costs incurred by The Contractor.

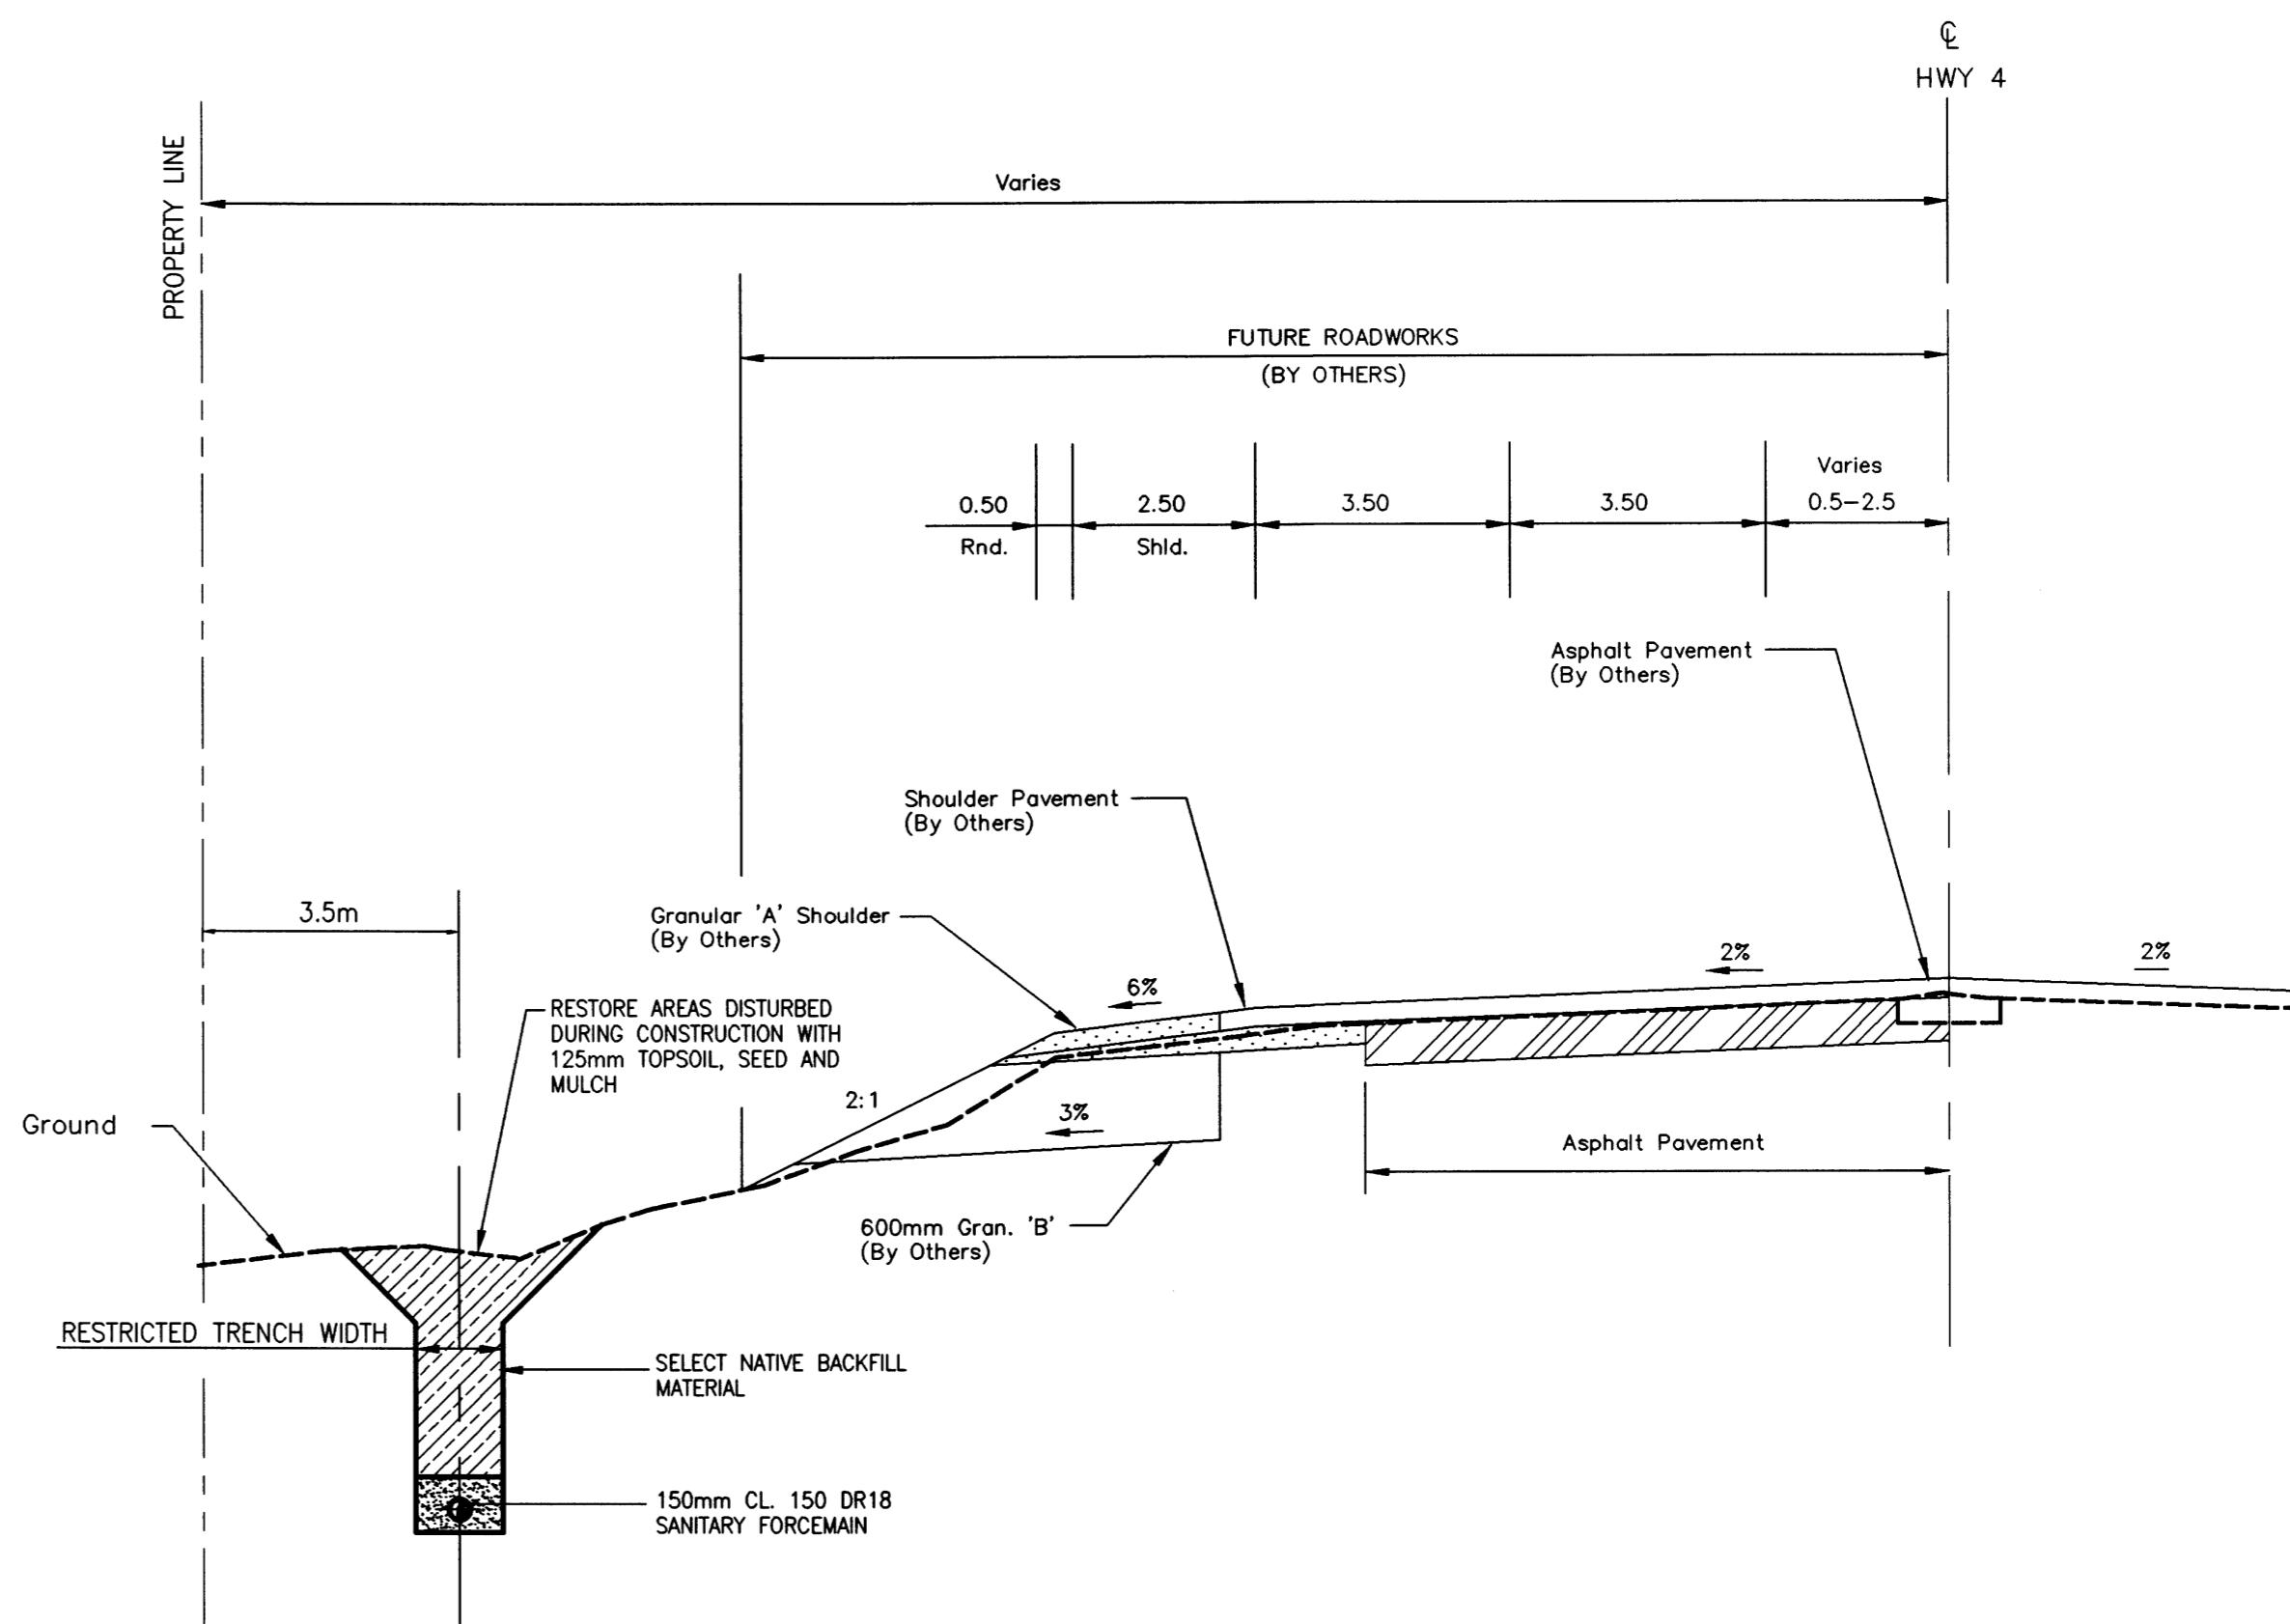


**RICHMOND STREET**

(STA. 10+400 TO STA. 11+250 AND STA. 11+375 TO STA. 11+550)

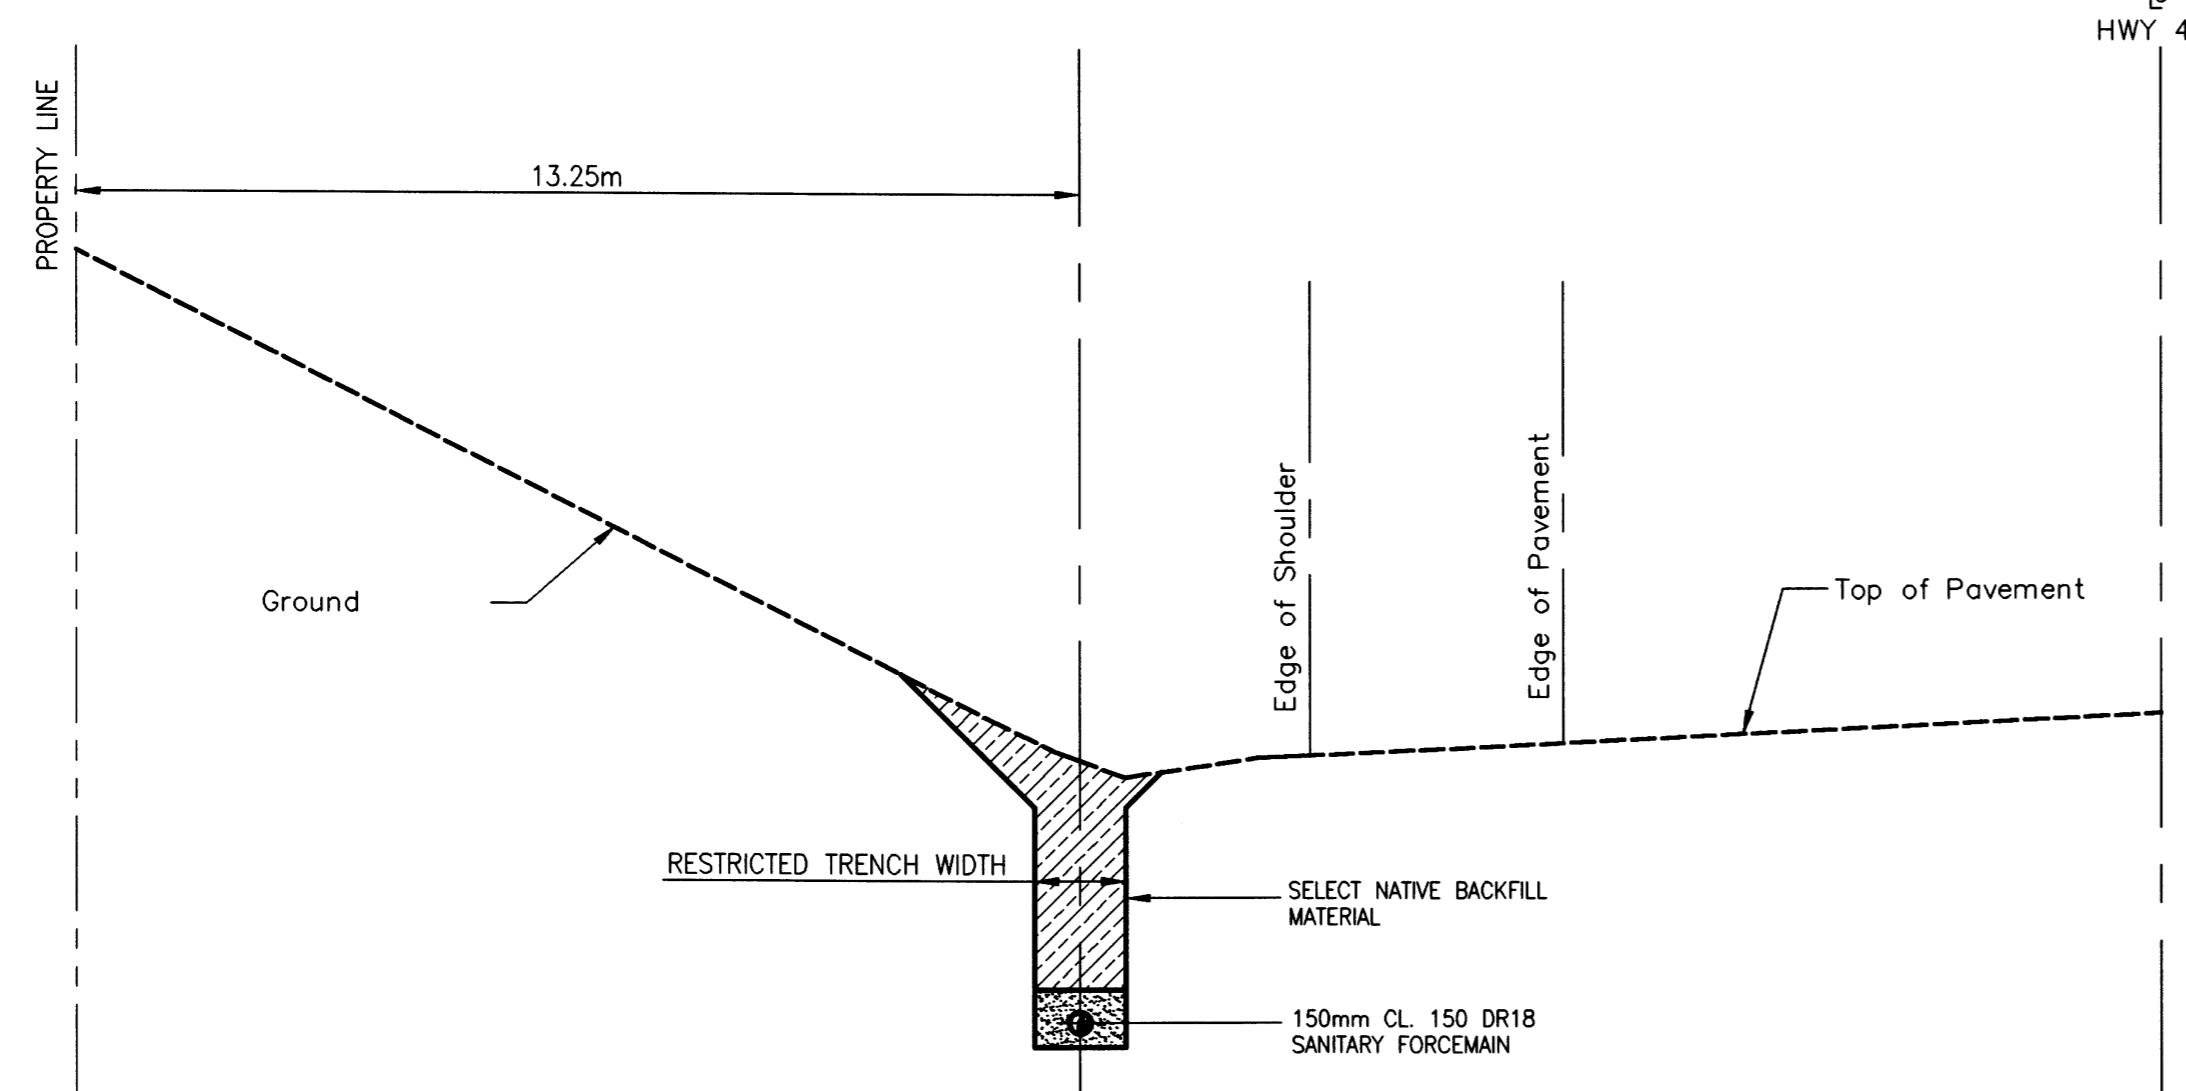

**RICHMOND STREET**

(STA. 11+250 TO STA. 11+375)

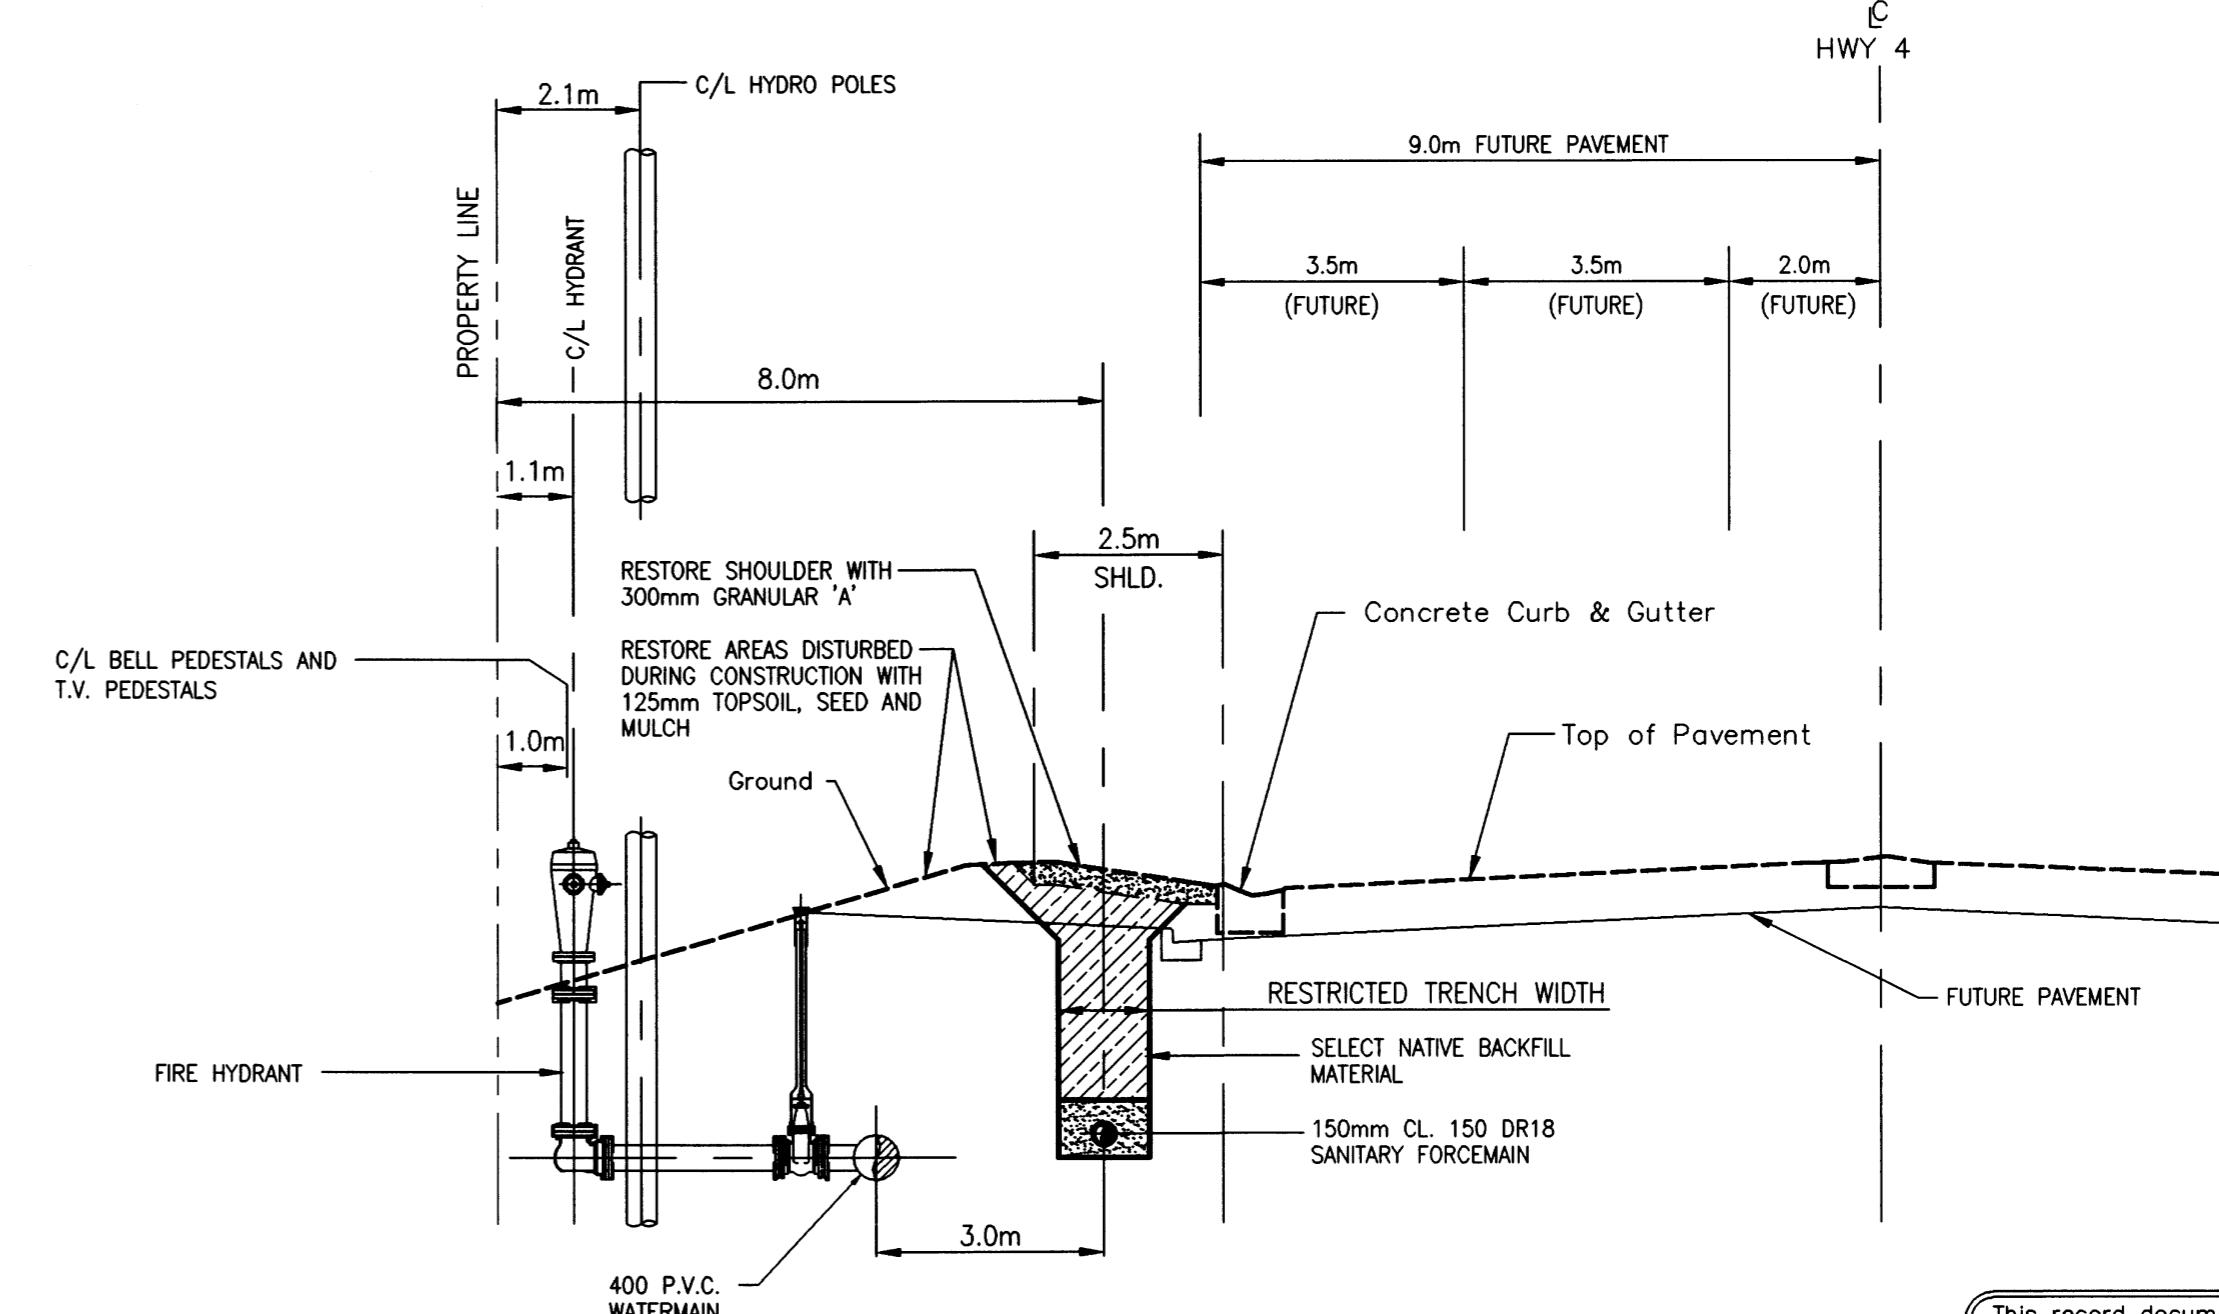

**RICHMOND STREET**


(STA. 10+095 TO STA. 10+400)

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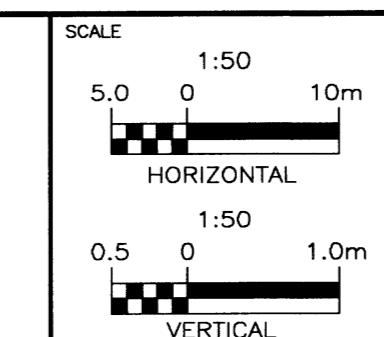
AS CONSTRUCTED NOTES	AS CONSTRUCTED SERVICES	COMPLETION	No	REVISIONS	DATE	BY
1		DESIGN PAK	1	AS CONSTRUCTED	NOV/01	WAB
2		DRAWN PAK				
3		CHECKED GOH				
4		APPROVED WAB				
5		DATE APRIL/2000				

**DILLON**  
CONSULTING

ENGINEERS STAMP  
*[Signature]*  
M. A. Boway

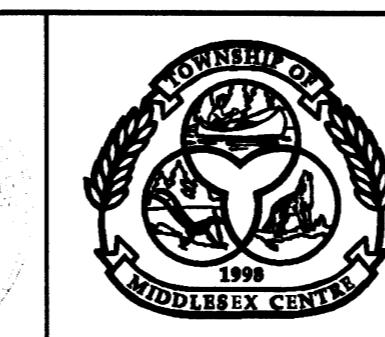

**TOWNSHIP  
OF  
MIDDLESEX  
CENTRE**



**ARVA SANITARY SEWAGE SYSTEM**  
**MISCELLANEOUS DETAILS TWO**

PROJECT No  
**00-7278**  
SHEET No  
**23**  
PLAN FILE No  
**23**

## GENERAL NOTES

All fill material placed within the right-of-way shall be placed in accordance with OPSS 206. In areas to be filled, the subgrade shall be proof rolled to obtain 95% Standard Proctor Density. Only acceptable earthen or granular materials shall be used within the road allowances.

No weeping tile or downspout connection will be permitted into the sanitary sewers.

All work shall be done in accordance with the minimum standards and specifications of the Township of Middlesex Centre..

Existing topographical information was obtained in the field by AGM.

All precast sewer manholes shall conform to the current ASTM designation of ASTM C478. For precast manholes on pipe sizes 250/200mm, 1200mm<sup>2</sup> chambers shall be used, unless otherwise noted on the drawings.

The structural design of the sewer pipes is based on transition width unless otherwise noted.

Type 1 bedding shall be in accordance with OPSD 202.04 for flexible sewer pipes. The Type 1 bedding material shall consist of approved OPSD Form 1010 Granular 'M' material or Granular 'A' material having a maximum aggregate size of 20mm. The cover material shall consist of a Type II Granular 'B' having a maximum aggregate size of 20mm.

All bedding material shall be compacted to a minimum of 95% of the material's Standard Proctor Maximum Dry Density (SPMDD).

Backfill shall be select native excavated material placed in thin layers compacted to at least 95% SPMDD or as specified.

All existing boulevards and road surfaces disturbed during construction shall be restored to a condition at least as good as original, all to the satisfaction of the Township Engineer.


All concrete shall be 25 MPa in 28 days unless otherwise stated.

## COMMON STANDARDS USED ON THIS PROJECT

OPSD-401.01 MAINTENANCE HOLE, CAST IRON COVER & SQUARE PLATE  
OPSD-404.02 SAFETY GRATING, ALUMINUM FOR CIRCULAR MANHOLES  
OPSD-405.01 MANHOLE STEPS  
OPSD-1001.01 PRECAST MANHOLE-1200mm<sup>2</sup>  
OPSD-1001.01 MANHOLE BEARING  
OPSD-1006.02 SEWER SERVICE CONNECTIONS FOR FLEXIBLE PIPE

## EROSION CONTROL MEASURES

- The Contractor shall construct temporary measures to control silt entering the storm drainage system, all to the specifications of the Village Engineer.
- Protect all exposed surfaces, and control all run-off during construction.
- All erosion control measures to be in place before starting construction and remain in place until restoration complete.
- Maintain erosion control measures during construction.
- All collected sediment to be disposed of at an approved location.
- Minimize area disturbed during construction.
- All dewatering to be disposed of in an approved sedimentation basin.
- Protect all catch basins, manholes, and pipe ends from sediment intrusion.
- Keep all ditches and sumps clean during construction.
- Prevent wind-blown dust.
- Straw bales to be used in localized areas as shown or as directed by the Engineer during construction.
- Provide a granular matt to prevent cohesive soil tracking at all entrances to existing roads.
- Sediment control measures to conform to "Guidelines for Urban Construction Sites, Ontario", May 1987.

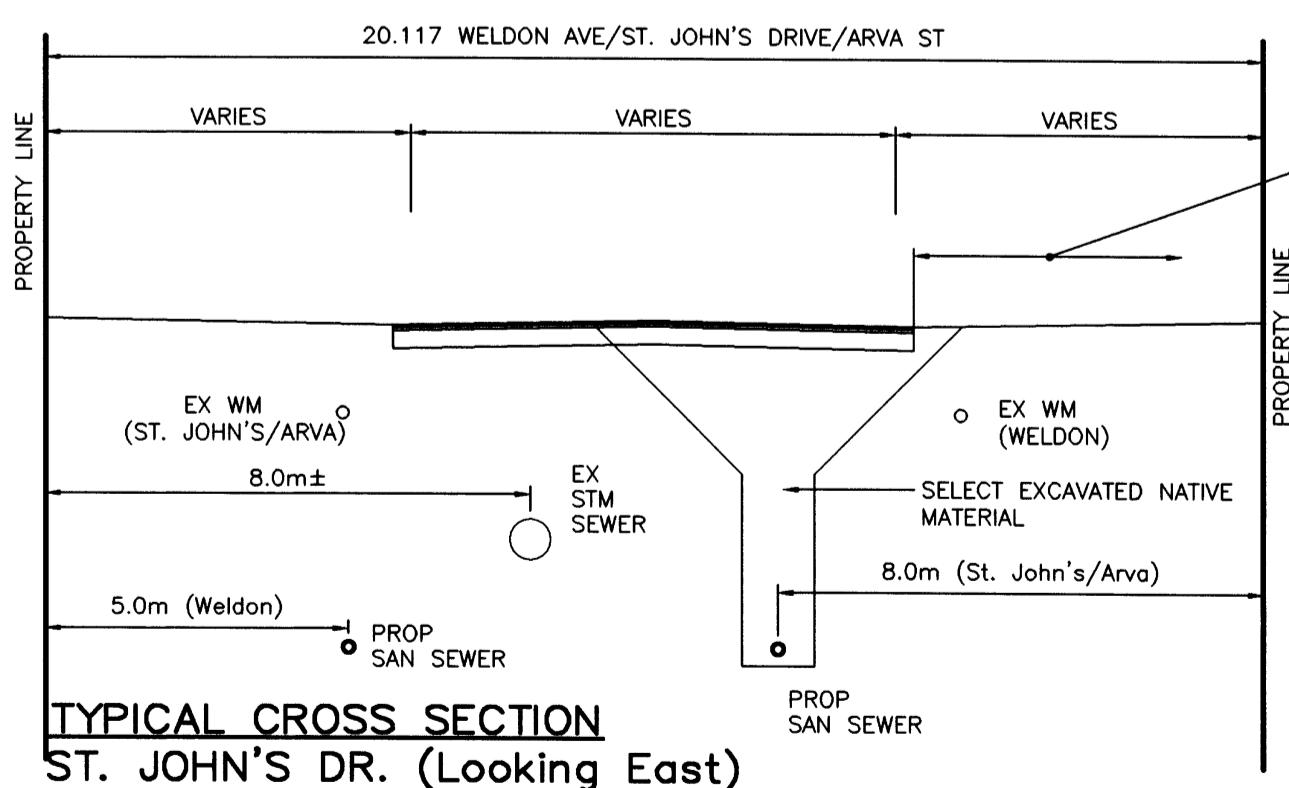


SCALE 1:250

RESTORATION:  
(TYP. BOTH SIDES)  
- 125mm TOPSOIL, SEED  
AND MULCH  
- DRIVEWAYS:  
ASPHALT: 65mm HL4  
GRAVEL: 300mm GRANULAR 'A'

PAVEMENT STRUCTURE  
200mm GRAN 'A'


RESTORATION RESTORE TO  
TOP OF GRANULAR 'A'.  
SURFACE TREATMENT BY TOWNSHIP.  
CONTRACTOR RESPONSIBLE FOR  
COORDINATION WITH TOWNSHIP.  
CONTRACTOR RESPONSIBLE FOR  
MAINTENANCE AND SURFACE  
PREPARATION PRIOR TO  
APPLICATION OF SURFACE  
TREATMENT. TOWNSHIP EXPECTS  
TO APPLY SURFACE TREATMENT IN  
EARLY SEPTEMBER.

This record document has been prepared  
in part upon information furnished  
by others. Dillon Consulting Limited cannot  
assess the accuracy of this information  
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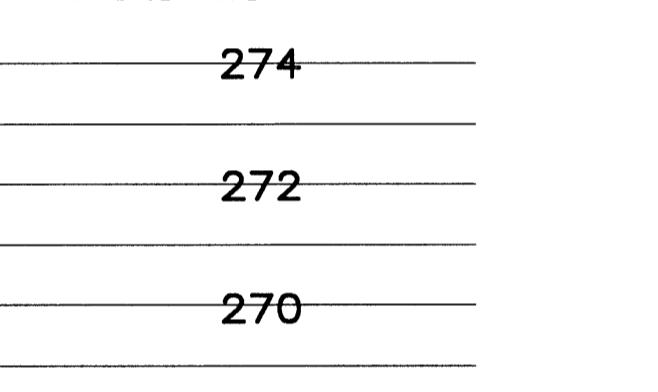


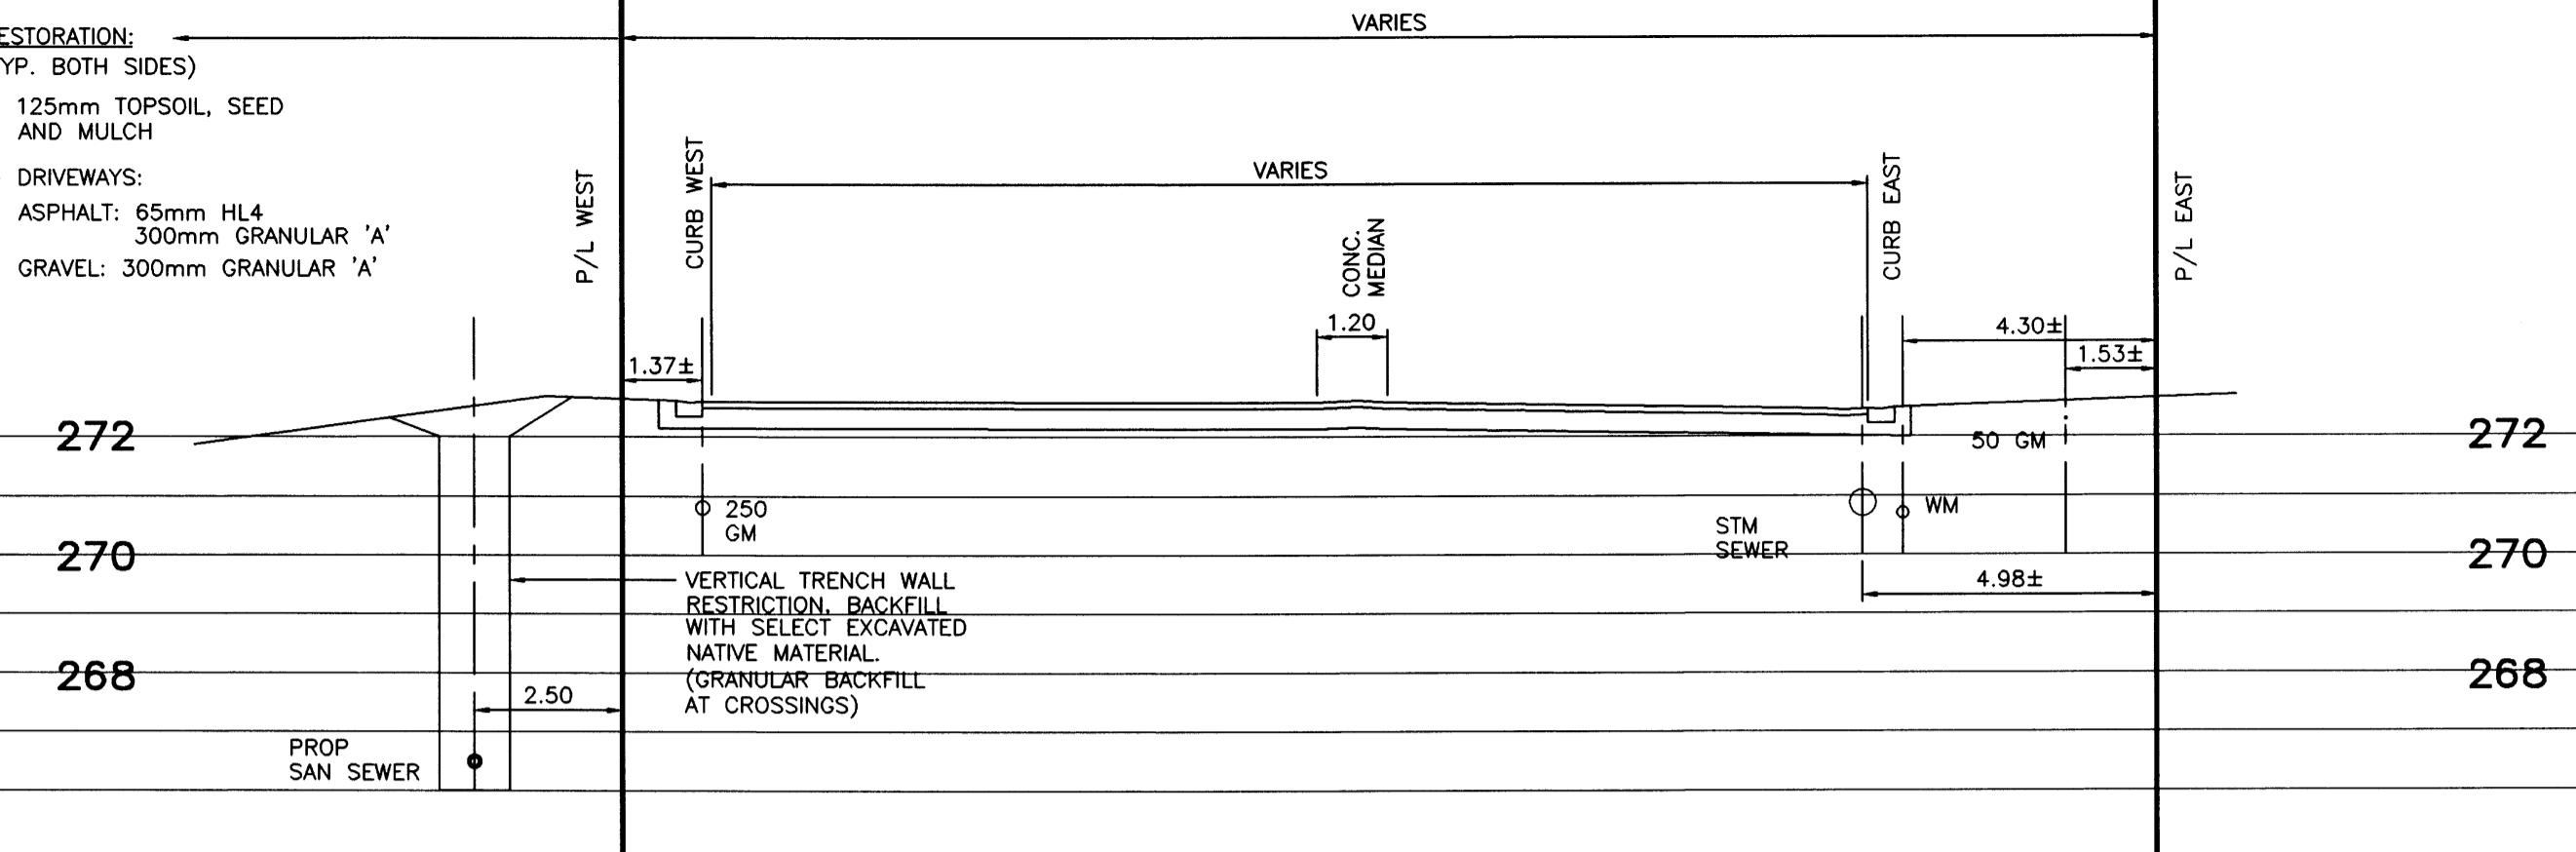TYPICAL CROSS SECTION OF RICHMOND STREET

SOUTH OF INTERSECTION WITH MEDWAY ROAD  
SCALE 1:250

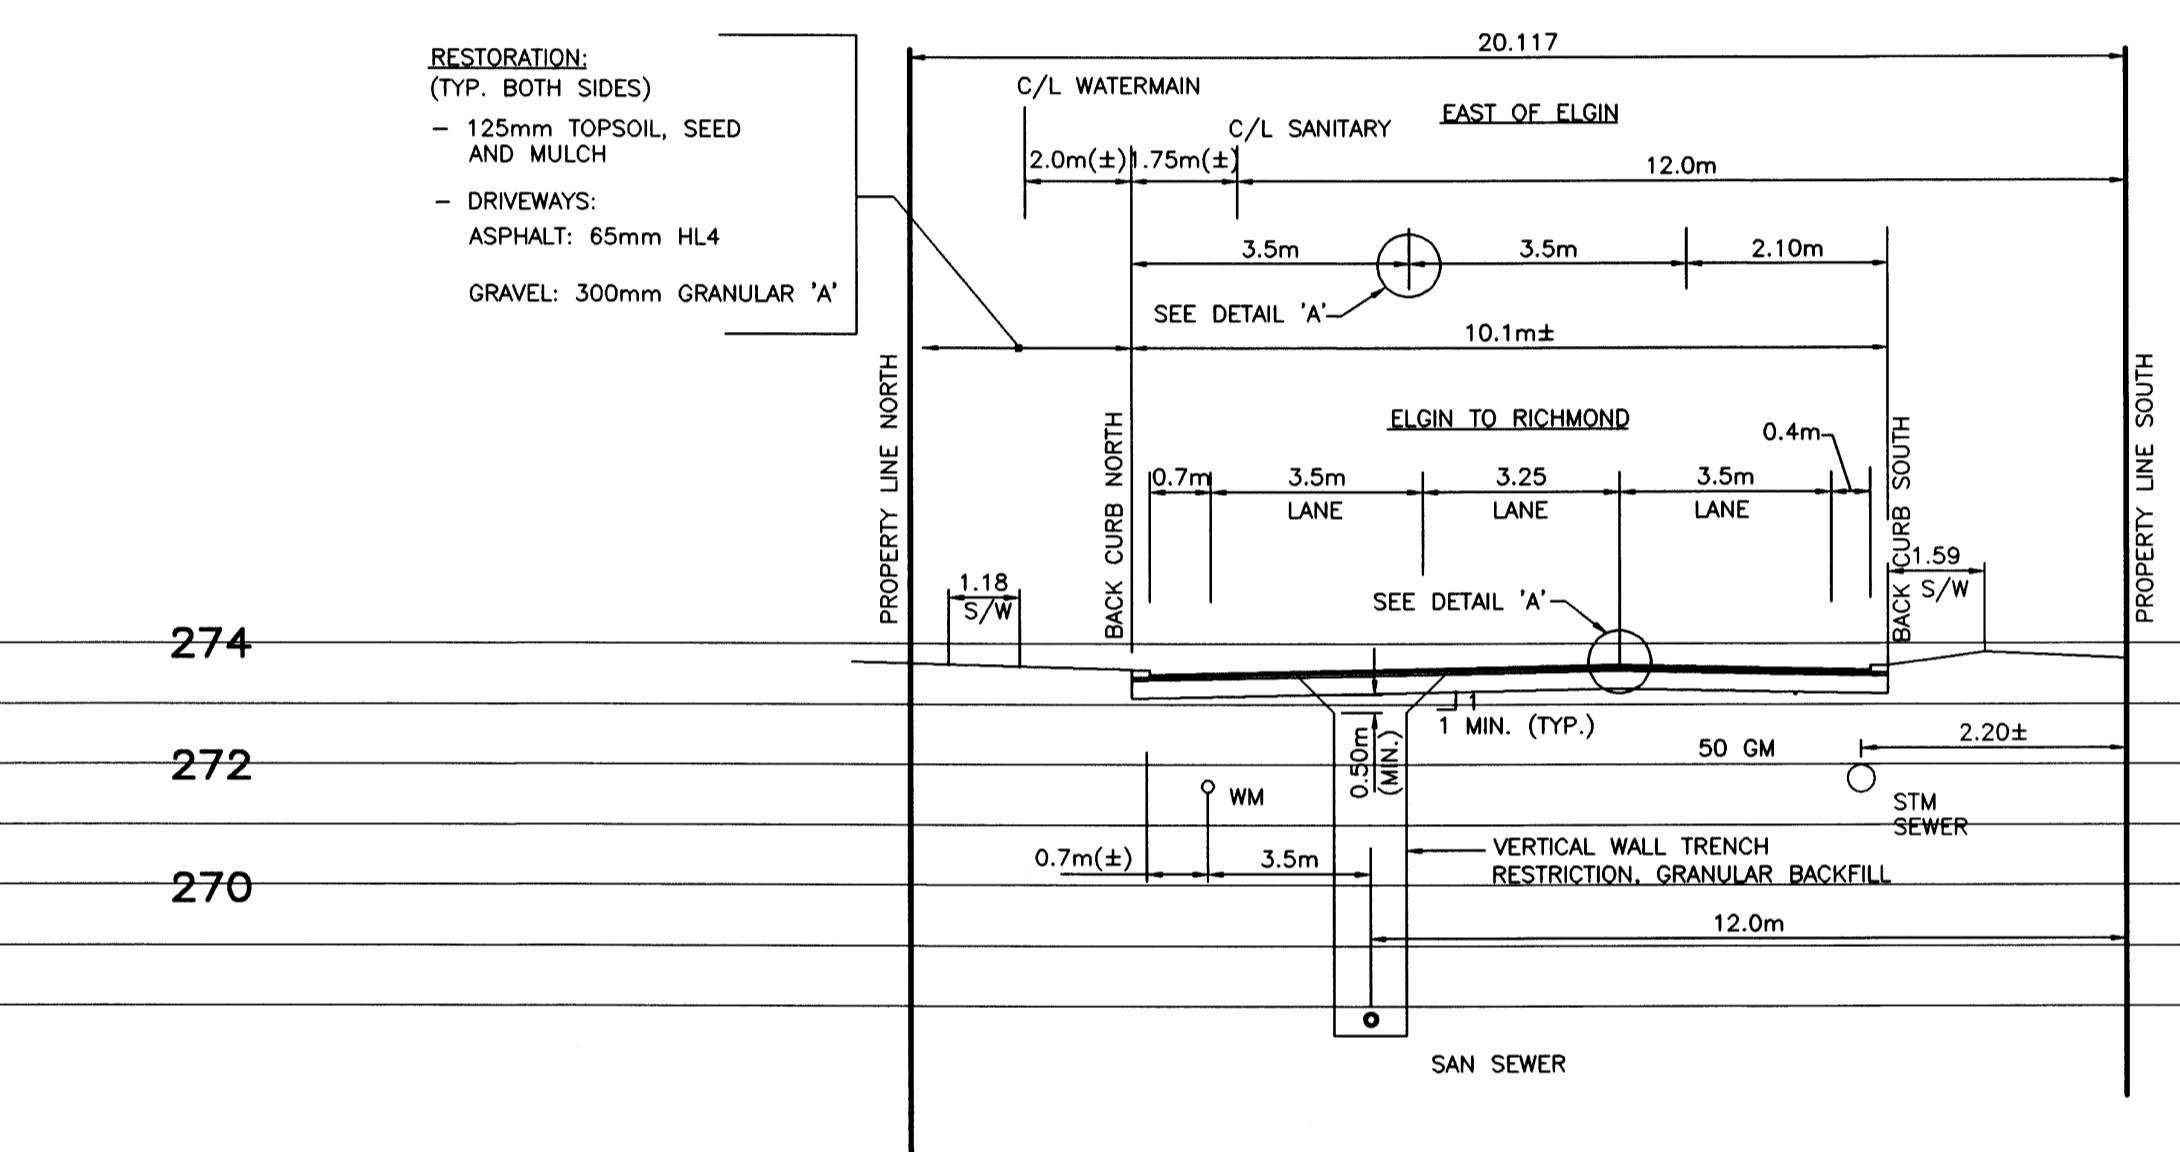


PAVEMENT STRUCTURE  
- (40 mm HL3) NOT PART OF THIS CONTRACT  
- 100mm HL8  
- 150mm GRAN A  
- 400mm GRAN B  
  
RESTORATION TO TOP OF BASE ASPHALT,  
LEAVE FRAMES AND GRATES, VALVE BOXES FLUSH  
WITH BASE ASPHALT. RAMP ALL FACES.




TYPICAL CROSS SECTION OF MEDWAY RD

EAST OF RICHMOND STREET  
SCALE 1:250

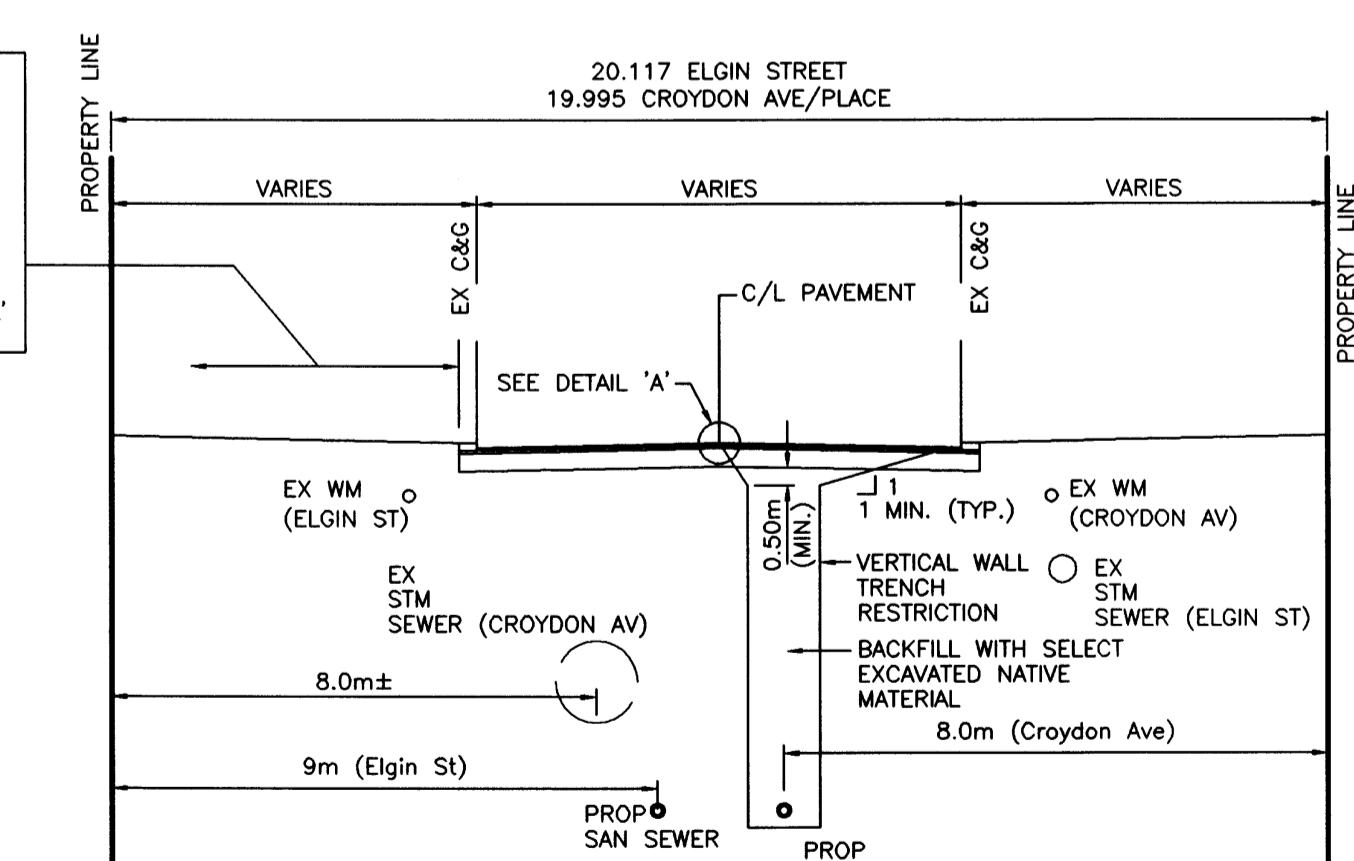



PAVEMENT STRUCTURE  
40 mm HL3 } ELGIN, 65mm HL4 CROYDON  
50mm HL8 }  
150mm GRAN A  
300mm GRAN B

RESTORATION RESTORE TO  
FINISHED ASPHALT  
REPLACE CONC C&G AS NECESSARY  
MATCH EXISTING

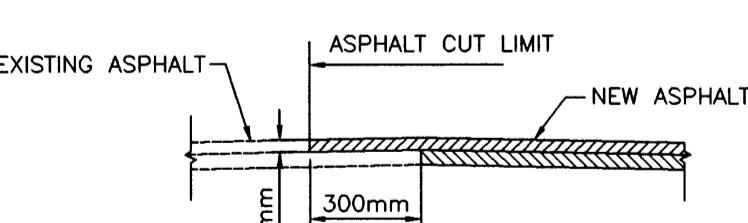

DETAIL 'A'

AS CONSTRUCTED NOTES	AS CONSTRUCTED SERVICES	COMPLETION	No	REVISIONS	DATE	BY
1	DESIGN RJM	1	AS CONSTRUCTED		SEPT 01	WAB
2	DRAWN EMB					
3	CHECKED WAB					
4	APPROVED					
5	DATE APR 20/00					

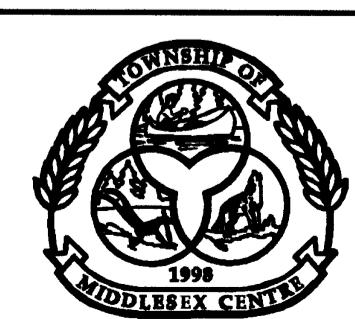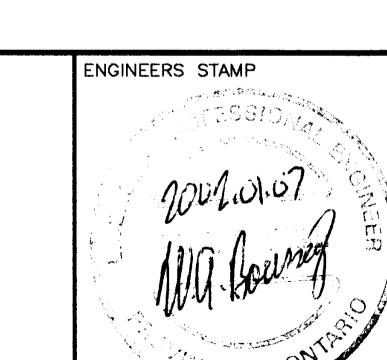

TOWNSHIP  
OF  
MIDDLESEX  
CENTRE

AS SHOWN

ARVA SANITARY SEWAGE SYSTEM  
MISCELLANEOUS DETAILS THREE  
COLLECTION SYSTEM

PROJECT No  
00-7278  
  
SHEET No  
24  
  
PLAN FILE No

